

	SITE DATA	
Zone	Name	m²
001	SITE AREA	457.07
002	LANDSCAPED AREA	174.26
003	SITE COVERAGE	150.41
004	IMPERMEABLE SURFACE	78.89

Development Data

Zone	Name	m²
01	GROUND FLOOR	138.87
02	FIRST FLOOR	151.93
03	ALFRESCO	53.56
04	PORCH	14.44
06	BALCONY	11.22

370.02 m²



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A13	LEVEL 1 FLOOR PLAN
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\dashv	A35	NOTIFICATION PLAN
\dashv	A36	PHOTOMONTAGE - EXISTING
	A37	PHOTOMONTAGE - PROPOSED
\neg		

RevID ID Revision

TACHARA GROUP




Copyright of this drawing is retained by Tachara Group. Authority is required for reproduction. Contractor to verify aoil dimensions on site prior to commencing work. Tachara Group is to be notified of any discrepancies in the dimension and setting out of the work.

CLIENT: Mr & Mrs Naguib

SCALE: 1:1.43, 1:1000, 1:100, 1:1, DRAWING NO: REV: PLOTTED: 3/1/2022 [O]



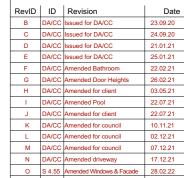

NOT FOR CONSTRUCTION

TACHARA GROUP



E info@tacharagroup.com.au

42 Dudley Street Pagewood, NSW 2035

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PROJECT: Proposed Residen

CLIENT: Mr & Mrs Naguib

113 Woolcott Street Earlwood NSW 2206 DRAWING: 3D VIEWS SCALE: 1:5.02 @A3 DRAWING NO: REV: PLOTTED: 3/1/2022 [O]

Connect Nata

General Notes:

All dimensions and floor areas are to verified by the Builder prior to

kny discrepancies are to be brought to the attention of the designer evels shown are approximate unless accompanied by reduced lev joured dimensions must be taken in preference to scaling.

Figured dimensions must be taken in preference to scaling. All boundary clearances must be verified by the surveyor prior the commencement of any building works.

reference to this drawing.

Stormwater to be discharged to Council's requirements and Australian Standards.

20 40 100 length in millimeters at full size

THESE NOTES MUST BE READ AND UNDERSTOOD BY ALL INVOLVED IN THE PROJECT.

THIS INCLUDES (but is not excluded to): OWNER, BUILDER, SUB-CONTRACTORS, CONSULTANTS, RENOVATORS, OPERATORS. MAINTENORS. DEMOLISHERS.

1. FALLS. SLIPS. TRIPS

a) WORKING AT HEIGHTS

DURING CONSTRUCTION

Wherever possible, components for this building should be prefabricated off-site or at ground level to minimise the risk of workers falling more than two metres. However, construction of this building will require workers to be working at heights where a fall in excess of two metres is possible and injury is likely to result from such a fall. The builder should provide a suitable barrier wherever a person is required to work in a situation where falling more than two metres is a possibility

DURING OPERATION OR MAINTENANCE

For houses or other low-rise buildings where scaffolding is

Cleaning and maintenance of windows, walls, roof or other components of this building will require persons to be situated where a fall from a height in excess of two metres is possible. Where this type of activity is required, scaffolding, ladders or trestles should be used in accordance with relevant codes of practice. regulations or legislation.

For buildings where scaffold, ladders, trestles are not appropriate: Cleaning and maintenance of windows walls, roof or other components of this building will require persons to be situated where a fall from a height in excess of two metres is possible. Where this type of activity is required, scaffolding, fall barriers or Personal Protective Equipment (PPE) should be used in accordance with relevant codes of practice, regulations or legislation.

b) SLIPPERY OR UNEVEN SURFACES

FLOOR FINISHES Specified

If finishes have been specified by designer, these have been selected to minimise the risk of floors and paved areas becoming slippery when wet or when walked on with wet shoes/feet. Any changes to the specified finish should be made in consultation with the designer or, if this is not practical, surfaces with an equivalent or better slip resistance should be chosen.

FLOOR FINISHES By Owner

If designer has not not been involved in the selection of surface finishes, the owner is responsible for the selection of surface finishes in the pedestrian trafficable areas of this building. Surfaces should be selected in accordance with AS HB 197:1999 and AS/NZ 4586:2004

STEPS, LOOSE OBJECTS AND UNEVEN SURFACES

Due to design restrictions for this building, steps and/or ramps are included in the building which may be a hazard to workers carrying objects or otherwise occupied. Steps should be clearly marked with both visual and tactile warning during construction, maintenance. demolition and at all times when the building operates as a workplace.

Building owners and occupiers should monitor the pedestrian access ways and in particular access to areas where maintenance is routinely carried out to ensure that surfaces have not moved or cracked so that they become uneven and present a trip hazard. Spills, loose material, stray objects or any other matter that may cause a slip or trip hazard should be cleaned or removed from access ways.

Contractors should be required to maintain a tidy work site during construction, maintenance or demolition to reduce the risk of trips and falls in the workplace. Materials for construction or maintenance should be stored in designated areas away from access ways and work areas.

2. FALLING OBJECTS

LOOSE MATERIALS OR SMALL OBJECTS

Construction, maintenance or demolition work on or around this building is likely to involve persons working above ground level or above floor levels. Where this occurs one or more of the following measures should be taken to avoid objects falling from the area where the work is being carried out onto persons below.

- 1. Prevent or restrict access to areas below where the work is being carried out.
- Provide toeboards to scaffolding or work platforms.
- Provide protective structure below the work area.
- Ensure that all persons below the work area have Personal Protective Equipment (PPE).

BUILDING COMPONENTS

During construction, renovation or demolition of this building, parts of the structure including fabricated steelwork, heavy panels and many other components will remain standing prior to or after supporting parts are in place. Contractors should ensure that temporary bracing or other required support is in place at all times when collapse which may injure persons in the area is a possibility.

Mechanical lifting of materials and components during construction, maintenance or demolition presents a risk of falling objects. Contractors should ensure that appropriate lifting devices are used. that loads are properly secured and that access to areas below the load is prevented or restricted.

3. TRAFFIC MANAGEMENT

For building on a major road, narrow road or steeply sloping road: Parking of vehicles or loading/unloading of vehicles on this roadway may cause a traffic hazard. During construction, maintenance or demolition of this building designated parking for workers and loading areas should be provided. Trained traffic management personnel should be responsible for the supervision of these areas. For building where on-site loading/unloading is restricted: Construction of this building will require loading and unloading of materials on the roadway. Deliveries should be well planned to avoid congestion of loading areas and trained traffic management personnel should be used to supervise loading/unloading areas. For all buildings:

Busy construction and demolition sites present a risk of collision where deliveries and other traffic are moving within the site. A traffic management plan supervised by trained traffic management personnel should be adopted for the work site.

4. SERVICES

Rupture of services during excavation or other activity creates a variety of risks including release of hazardous material. Existing services are located on or around this site. Where known, these are identified on the plans but the exact location and extent of services may vary from that indicated. Services should be located using an appropriate service (such as Dial Before You Dig), appropriate excavation practice should be used and, where necessary, specialist contractors should be used. Locations with underground power:

Underground power lines MAY be located in or around this site. All underground power lines must be disconnected or carefully located and adequate warning signs used prior to any construction, maintenance or demolition commencing. Locations with overhead power lines:

Overhead power lines MAY be near or on this site. These pose a risk of electrocution if struck or approached by lifting devices or other plant and persons working above ground level. Where there is a danger of this occurring, power lines should be, where practical, disconnected or relocated. Where this is not practical adequate warning in the form of bright coloured tape or signage should be used or a protective barrier provided.

5. MANUAL TASKS

Components within this design with a mass in excess of 25kg should be lifted by two or more workers or by mechanical lifting device. Where this is not practical, suppliers or fabricators should be required to limit the component mass.

All material packaging, building and maintenance components should clearly show the total mass of packages and where practical all items should be stored on site in a way which minimises bending before lifting. Advice should be provided on safe lifting methods in all areas where lifting may occur. Construction, maintenance and demolition of this building will require the use of portable tools and equipment. These should be fully maintained in accordance with manufacturer's specifications and not used where faulty or (in the case of electrical equipment) not carrying a current electrical safety tag. All safety guards or devices should be regularly checked and Personal Protective Equipment should be used in accordance with manufacturer's specification.

6. HAZARDOUS SUBSTANCES **ASBESTOS**

For alterations to a building constructed prior to 1990: If this existing building was constructed prior to: 1990 - it therefore may contain asbestos 1986 - it therefore is likely to contain asbestos either in cladding material or in fire retardant insulation material. In either case, the builder should check and, if necessary, take appropriate action before demolishing, cutting, sanding, drilling or otherwise disturbing the existing structure.

POWDERED MATERIALS

Many materials used in the construction of this building can cause harm if inhaled in powdered form. Persons working on or in the building during construction, operational maintenance or demolition should ensure good ventilation and wear Personal Protective Equipment including protection against inhalation while using powdered material or when sanding, drilling, cutting or otherwise disturbing or creating powdered material.

TREATED TIMBER

The design of this building may include provision for the inclusion of treated timber within the structure. Dust or fumes from this material can be harmful. Persons working on or in the building during construction, operational maintenance or demolition should ensure good ventilation and wear Personal Protective Equipment including protection against inhalation of harmful material when sanding, drilling, cutting or using treated timber in any way that may cause harmful material to be released. Do not burn treated timber.

VOLATILE ORGANIC COMPOUNDS

Many types of glue, solvents, spray packs, paints, varnishes and some cleaning materials and disinfectants have dangerous emissions. Areas where these are used should be kept well ventilated while the material is being used and for a period after installation. Personal Protective Equipment may also be required. The manufacturer's recommendations for use must be carefully considered at all times.

SYNTHETIC MINERAL FIBRE

Fibreglass, rockwool, ceramic and other material used for thermal or sound insulation may contain synthetic mineral fibre which may be harmful if inhaled or if it comes in contact with the skin, eyes or other sensitive parts or the body. Personal Protective Equipment including protection against inhalation of harmful material should be used when installing, removing or working near bulk insulation material.

TIMBER FLOORS

This building may contain timber floors which have an applied finish. Areas where finishes are applied should be kept well ventilated during sanding and application and for a period after installation. Personal Protective Equipment may also be required. The manufacturer's recommendations for use must be carefully considered at all times.

7. CONFINED SPACES **EXCAVATION**

Construction of this building and some maintenance on the building will require excavation and installation of items within excavations. Where practical, installation should be carried out using methods which do not require workers to enter the excavation. Where this is not practical, adequate support for the excavated area should be provided to prevent collapse. Warning signs and barriers to prevent accidental or unauthorised access to all excavations should be provided.

ENCLOSED SPACES

For buildings with enclosed spaces where maintenance or other access may be required:

Enclosed spaces within this building may present a risk to persons entering for construction, maintenance or any other purpose. The design documentation calls for warning signs and barriers to unauthorised access. These should be maintained throughout the life of the building. Where workers are required to enter enclosed spaces, air testing equipment and Personal Protective Equipment should be provided.

SMALL SPACES

For buildings with small spaces where maintenance or other access may be required:

Some small spaces within this building will require access by construction or maintenance workers. The design documentation calls for warning signs and barriers to unauthorised access. These should be maintained throughout the life of the building. Where workers are required to enter small spaces they should be scheduled so that access is for short periods. Manual lifting and other manual activity should be restricted in small spaces.

8. PUBLIC ACCESS

Public access to construction and demolition sites and to areas under maintenance causes risk to workers and public. Warning DA/CC Amended driveway 17.12.21 signs and secure barriers to unauthorised access should be provided. Where electrical installations, excavations, plant or loose materials are present they should be secured when not fully supervised

9. OPERATIONAL USE OF BUILDING RESIDENTIAL BUILDINGS

This building has been designed as a residential building. If it, at a later date, it is used or intended to be used as a workplade, the provisions of the Work Health and Safety Act 2011 or subsequent replacement Act should be applied to the new use.

9.OTHER HIGH RISK ACTIVITY

All electrical work should be carried out in accordance with Code of Practice: Managing Electrical Risks at the Workplace, AS/NZ 3012 and all licensing requirements.

All work using Plant should be carried out in accordance with Code of Practice: Managing Risks of Plant at the Workplace. All work should be carried out in accordance with

Practice: Managing Noise and Preventing Hearing Loss at Work. Due to the history of serious incidents it is recommended that

construction and concrete placement. All the above applies

NOT FOR particular care be exercised when undertaking work involving steCONSTRUCTION

RevID | ID | Revision

DA/CC Issued for DA/C0

DA/CC Amended Pool

J DA/CC Amended for client

K DA/CC Amended for council

L DA/CC Amended for council

DA/CC Amended Door Heights

22.02.21

26.02.21

22.07.21

22.07.21

10.11.21

02.12.21

07.12.21

F DA/CC Amended Bathroo

TACHARA GROUP



12 Dudley Street Pagewood, NSW 2035

CLIENT: Mr & Mrs Naguib NOTES & LEGENDS SCALE: 1:50 @A3 DRAWING NO: RE A03

All dimensions and floor areas are to verified by the Builder prior to commencement of any building work. Any discrepancies are to be brought to the attention of the designer. Levels shown are approximate unless accompanied by reduced levels

All boundary clearances must be verified by the surveyor prior to the commencement of any building works.

revices to be located and verified by the Builder with relevan

Building Sustainability Index www.basix.nsw.gov.au

Single Dwelling

Certificate number: 1141733S_03

This certificate confirms that the proposed development will meet the NSW government's requirements for sustainability, if it is built in accordance with the commitments set out below. Terms used in this certificate, or in the commitments, have the meaning given by the document entitled "BASIX Definitions" dated 10/09/2020 published by the Department. This document is available at www.basix.nsw.gov.au

Secretary
Date of issue: Monday, 22 February 2021
To be valid, this certificate must be lodged within 3 months of the date of issue.



Project summary			
Project name	BTA-113 Woolcott S	Street Earlwood 2206_03	
treet address 113 Woolcott Street Earlwood 2206			
Local Government Area Canterbury-Bankstown Council			
Plan type and plan number	deposited 211306		
Lot no.	3		
Section no.	-		
Project type	separate dwelling house		
No. of bedrooms	5		
Project score			
Water	✓ 40	Target 40	
Thermal Comfort	✓ Pass	Target Pass	
Energy	✓ 51	Target 50	

С	ertificate Prepared by
N	ame / Company Name: Sustainability-Z Pty Ltd
Al	BN (if applicable): 59622331935

BASIX Planning, Industry & Environment www.basix.nsw.gov.au Version: 3.0 / DARWINIA_3_15_1 Certificate No.: 1141733S_03 Monday, 22 February 2021 page 1/7

Description of project

Project name	BTA-113 Woolcott Street Earlwood 2206_03		
Street address	113 Woolcott Street Earlwood 2206		
Local Government Area	Canterbury-Bankstown Council		
Plan type and plan number	Deposited Plan 211306		
Lot no.	3		
Section no.	-		
Project type			
Project type	separate dwelling house		
No. of bedrooms	5		
Site details			
Site area (m²)	457		
Roof area (m²)	243		
Conditioned floor area (m2)	231.0		
Unconditioned floor area (m2)	15.0		
Total area of garden and lawn (m2)	188		

Assessor number	DMN/13/1641			
Certificate number	0005256862-2			
Climate zone	56	56		
Area adjusted cooling load (MJ/m².year)	26			
Area adjusted heating load (MJ/m².year)	40			
Ceiling fan in at least one bedroom	Yes			
Ceiling fan in at least one living room or other conditioned area				
Project score				
Water	✓ 40	Target 40		
Thermal Comfort	✓ Pass	Target Pass		
Energy	✓ 51	Target 50		

NOT FOR CONSTRUCTION

RevID | ID | Revision

B DA/CC Issued for DA/CC
C DA/CC Issued for DA/CC

F DA/CC Amended Bathroom

J DA/CC Amended for client

K DA/CC Amended for council

L DA/CC Amended for council

N DA/CC Amended driveway

M DA/CC Amended for council

O S 4.55 Amended Windows & Facade 28.02.22

G DA/CC Amended Door Heights
H DA/CC Amended for client
I DA/CC Amended Pool

Date

22.02.21

26.02.21

22.07.21

22.07.21

10.11.21

02.12.21

07.12.21

17.12.21

Schedule of BASIX commitments

The commitments set out below regulate how the proposed development is to be carried out. It is a condition of any development consent granted, or complying development certificate issued, for the proposed development, that BASIX commitments be complied with.

	DA plans	plans & specs	check
Fixtures			
The applicant must install showerheads with a minimum rating of 3 star (> 7.5 but <= 9 L/min) in all showers in the development.		~	•
The applicant must install a toilet flushing system with a minimum rating of 4 star in each toilet in the development.		V	~
The applicant must install taps with a minimum rating of 5 star in the kitchen in the development.		~	
The applicant must install basin taps with a minimum rating of 5 star in each bathroom in the development.		~	
Alternative water			
Rainwater tank			
The applicant must install a rainwater tank of at least 2000 litres on the site. This rainwater tank must meet, and be installed in accordance with, the requirements of all applicable regulatory authorities.	V	~	~
accordance with the requirements of an applicable regulatory dutilenties.			
The applicant must configure the rainwater tank to collect rain runoff from at least 60 square metres of the roof area of the development (excluding the area of the roof which drains to any stormwater tank or private dam).		_	
The applicant must configure the rainwater tank to collect rain runoff from at least 60 square metres of the roof area of the development		_	<u> </u>
The applicant must configure the rainwater tank to collect rain runoff from at least 60 square metres of the roof area of the development (excluding the area of the roof which drains to any stormwater tank or private dam).		,	-
The applicant must configure the rainwater tank to collect rain runoff from at least 60 square metres of the roof area of the development (excluding the area of the roof which drains to any stormwater tank or private dam). The applicant must connect the rainwater tank to:		*	~

Thermal Comfort Commitments	Show on DA plans	Show on CC/CDC plans & specs	Certifier check
Simulation Method			
The applicant must attach the certificate referred to under "Assessor Details" on the front page of this BASIX certificate (the "Assessor Certificate") to the development application and construction certificate application for the proposed development (or, if the applicant is applying for a complying development certificate for the proposed development, to that application). The applicant must also attach the Assessor Certificate to the application for an occupation certificate for the proposed development.			
The Assessor Certificate must have been issued by an Accredited Assessor in accordance with the Thermal Comfort Protocol.			
The details of the proposed development on the Assessor Certificate must be consistent with the details shown in this BASIX certificate, including the Cooling and Heating loads shown on the front page of this certificate.			
The applicant must show on the plans accompanying the development application for the proposed development, all matters which the Assessor Certificate requires to be shown on those plans. Those plans must bear a stamp of endorsement from the Accredited Assessor to certify that this is the case. The applicant must show on the plans accompanying the application for a construction certificate (or complying development certificate, if applicable), all thermal performance specifications set out in the Assessor Certificate, and all aspects of the proposed development which were used to calculate those specifications.	•	•	~
The applicant must construct the development in accordance with all thermal performance specifications set out in the Assessor Certificate, and in accordance with those aspects of the development application or application for a complying development certificate which were used to calculate those specifications.		~	~
The applicant must show on the plans accompanying the development application for the proposed development, the locations of ceiling fans set out in the Assessor Certificate. The applicant must show on the plans accompanying the application for a construction certificate (or complying development certificate, if applicable), the locations of ceiling fans set out in the Assessor Certificate.	~	~	~
The applicant must construct the floors and walls of the dwelling in accordance with the specifications listed in the table below.		~	-

Planning, Industry & Environment www.basix.nsw.gov.au Version: 3.0 / DARWINIA_3_15_1 Certificate No.: 1141733S_03 Monday, 22 February 2021

Floor and wall construction	Area
floor - concrete slab on ground	6.0 square metres
floor - suspended floor/open subfloor	22.0 square metres
floor - suspended floor above garage	All or part of floor area

BASIX Planning, Industry & Environment www.basix.nsw.gov.au Version: 3.0 / DARWINIA_3_15_1 Certificate No.: 1141733S_03 Monday, 22 February 2021

113 Woolcott Street Earlwood NSW 2206 DRAWING: BASIX

SCALE: 1:1.67 @A3 DRAWING NO: REV: PLOTTED: 3/1/2022 [O] A04

NSW REG. 10694 ABN 65 614 218 192

PROJECT NO2020-020

CLIENT: Mr & Mrs Naguib

All dimensions and floor areas are to verified by the Builder prior to commencement of any building work. Any discrepancies are to be brought to the attention of the designer. Levels shown are approximate unless accompanied by reduced levels. Figured dimensions must be taken in preference to scaling. All boundary clearances must be verified by the surveyor prior to the commencement of any building works. Where engineering drawings are required such must take preference to this drawing. Stormwater to be discharged to Council's requirements and Australian Broundards.

TACHARA GROUP

42 Dudley Street Pagewood, NSW 2035

All services to be located and verified by the Builder with relevant authorities before any building work commences.

length in millimeters at full size

BASIX Planning, Industry & Environment www.basix.nsw.gov.au Version: 3.0 / DARWINIA_3_15_1 Certificate No.: 1141733S_03 Monday, 22 February 2021

Energy Commitments	Show on DA plans	Show on CC/CDC plans & specs	Certifier check
Hot water			
The applicant must install the following hot water system in the development, or a system with a higher energy rating: gas instantaneous with a performance of 5 stars.	~	V	~
Cooling system			
The applicant must install the following cooling system, or a system with a higher energy rating, in at least 1 living area: 1-phase airconditioning; Energy rating: EER 2.5 - 3.0		~	~
The applicant must install the following cooling system, or a system with a higher energy rating, in at least 1 bedroom: 1-phase airconditioning; Energy rating: EER 2.5 - 3.0		>	~
The cooling system must provide for day/night zoning between living areas and bedrooms.		✓	~
Heating system			
The applicant must install the following heating system, or a system with a higher energy rating, in at least 1 living area: 1-phase airconditioning; Energy rating: EER 2.5 - 3.0		~	~
The applicant must install the following heating system, or a system with a higher energy rating, in at least 1 bedroom: 1-phase airconditioning; Energy rating: EER 2.5 - 3.0		~	~
The heating system must provide for day/night zoning between living areas and bedrooms.		~	~
Ventilation			
The applicant must install the following exhaust systems in the development:			
At least 1 Bathroom: individual fan, ducted to façade or roof; Operation control: manual switch on/off		•	~
Kitchen: individual fan, ducted to façade or roof; Operation control: manual switch on/off		✓	~
Laundry: individual fan, ducted to façade or roof; Operation control: manual switch on/off		V	~
Artificial lighting			
The applicant must ensure that the "primary type of artificial lighting" is fluorescent or light emitting diode (LED) lighting in each of the following rooms, and where the word "dedicated" appears, the fittings for those lights must only be capable of accepting fluorescent or light emitting diode (LED) lamps:			
at least 6 of the bedrooms / study; dedicated		_	

Leg		
I ed	end	

In these commitments, "applicant" means the person carrying out the development.

Commitments identified with a w in the "Show on DA plans" column must be shown on the plans accompanying the development application for the proposed development (if a development application is to be lodged for the proposed development).

Commitments identified with a 📢 in the "Show on CC/CDC plans and specs" column must be shown in the plans and specifications accompanying the application for a construction certificate / complying development certificate for the proposed development.

Commitments identified with a 🕡 in the "Certifier check" column must be certified by a certifying authority as having been fulfilled, before a final occupation certificate(either interim or final) for the development may be issued.

BASIX Planning, Industry & Environment www.basix.nsw.gov.au Version: 3.0 / DARWINIA_3_15_1 Certificate No.: 1141733S_03 Monday, 22 February 2021

Energy Commitments Show on DA plans Show on CC/CDC Certifier check at least 3 of the living / dining rooms; dedicated · the kitchen; dedicated · all bathrooms/toilets; dedicated • the laundry; dedicated · all hallways; dedicated Natural lighting The applicant must install a window and/or skylight in the kitchen of the dwelling for natural lighting. The applicant must install a window and/or skylight in 3 bathroom(s)/toilet(s) in the development for natural lighting. V The applicant must install a gas cooktop & electric oven in the kitchen of the dwelling. The applicant must install a fixed outdoor clothes drying line as part of the development.

BASIX Planning, Industry & Environment www.basix.nsw.gov.au Version: 3.0 / DARWINIA_3_15_1 Certificate No.: 1141733\$ 03 Monday, 22 February 2021

RevID ID Revision Date B DA/CC Issued for DA/CC
C DA/CC Issued for DA/CC 23.09.20 24.09.20 F DA/CC Amended Bathroom 22.02.21 G DA/CC Amended Door Heights 26.02.21 H DA/CC Amended for client
I DA/CC Amended Pool 22.07.21 J DA/CC Amended for client 22.07.21 K DA/CC Amended for council 10.11.21 L DA/CC Amended for council 02.12.21 M DA/CC Amended for council 07.12.21 N DA/CC Amended driveway 17.12.21 O S 4.55 Amended Windows & Facade 28.02.22

> NOT FOR CONSTRUCTION

page 6/7

TACHARA GROUP



NSW REG. 10694 ABN 65 614 218 192

PROJECT NO2020-020

42 Dudley Street Pagewood, NSW 2035

CLIENT: Mr & Mrs Naguib

SCALE: 1:1.67 @A3 DRAWING NO: REV: PLOTTED: 3/1/2022 [O] 113 Woolcott Street Earlwood NSW 2206 DRAWING: BASIX


General Notes:


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All boundary clearances must be wrifted by the surveyor prior to
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Where engineering drewings are required such must take
preference to this drawing.
Stormwater to be discharged to Council's requirements
and Australian Standards.

All services to be located and verified by the Builder with relevant authorities before any building work commences.

100 length in millimeters at full size



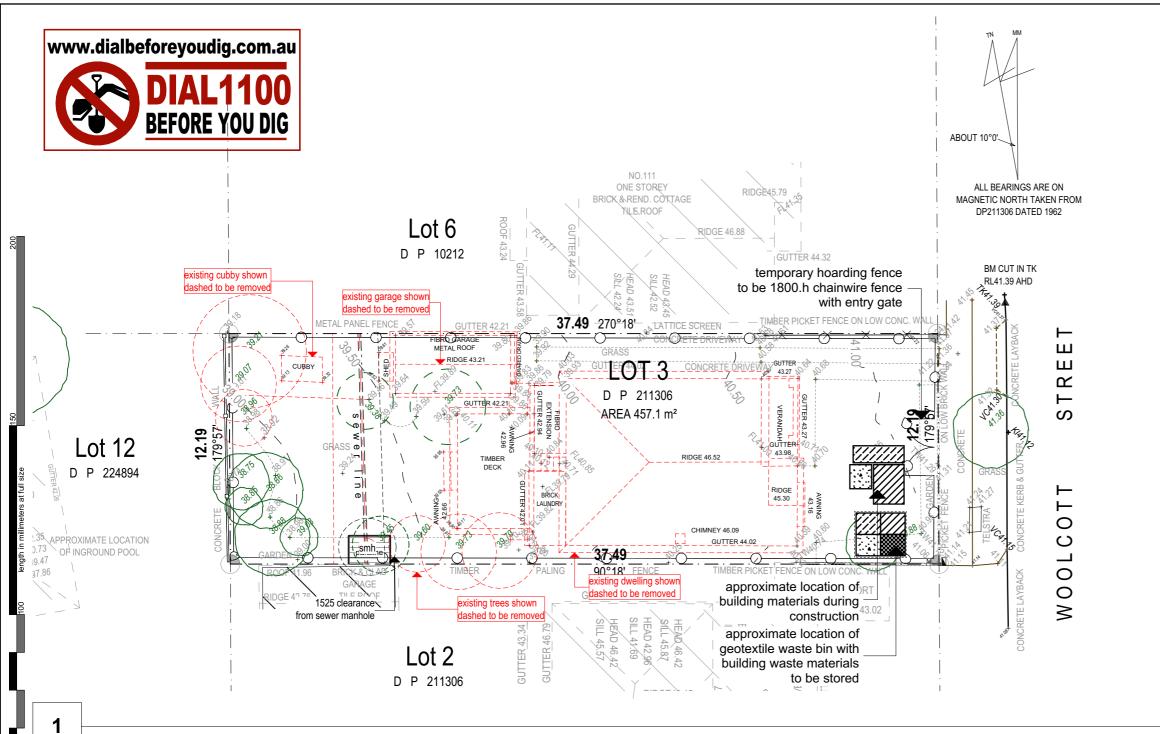


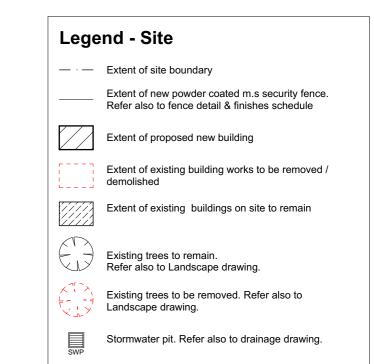
Existing level. Refer also to survey.


Existing telstra pit. Refer also to survey.


Proposed levels,. Refer also to drainage drawing.


SITE DEMOLITION PLAN

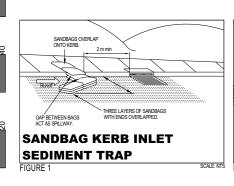


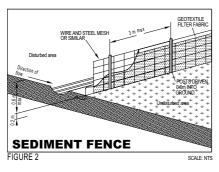

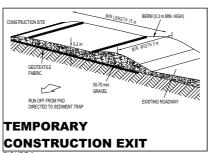

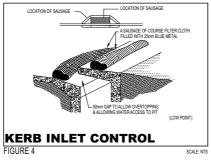

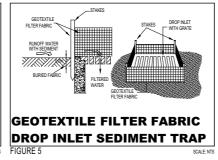

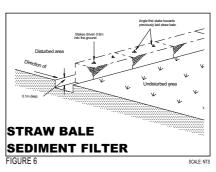

General Notes:	RevID	ID	Revi
All dimensions and floor areas are to verified by the Builder prior to commencement of any building work	Н	DA/CC	Amen
Any discrepancies are to be brought to the attention of the designer.		DA/CC	Amen
Levels shown are approximate unless accompanied by reduced levels. Figured dimensions must be taken in preference to scaling.	J	DA/CC	Amen
All boundary clearances must be verified by the surveyor prior to	K	DA/CC	Amen
the commencement of any building works.	L	DA/CC	Amen
Where engineering drawings are required such must take preference to this drawing.	M	DA/CC	Amen
Stormwater to be discharged to Council's requirements and Australian Standards	N	DA/CC	Amen
All services to be located and verified by the Builder with relevant	0	S 4.55	Amend

Revio	טו ן	Revision	Date
Н	DA/CC	Amended for client	03.05.21
- 1	DA/CC	Amended pool	22.07.21
J	DA/CC	Amended for client	22.07.21
K	DA/CC	Amended for council	10.11.21
L	DA/CC	Amended for council	02.12.21
M	DA/CC	Amended for council	07.12.21
N	DA/CC	Amended driveway	17.12.21
0	S 4.55	Amended Windows & Facade	28.02.2022





CLIENT: Mr & Mrs Naguib

SITE DEMOLITION PLAN

SCALE: 1:100, 1:200, 1:125 @A3 DRAWING NO: REV: PLOTTED: 3/1/2022 [O] A06



RevID ID Revision 22.02.21 26.02.21 03.05.21 22.07.21 22.07.21 K DA/CC Amended for council 10.11.21 02.12.21 07.12.21 17.12.21 O S 4.55 Amended Windows & Facade 28.02.22

DEEPSOIL DATA

Site Area: 457.07m² 91.41m² 20%required: Provided: 93.19m²

NOT FOR CONSTRUCTION



TACHARA GROUP



NSW REG. 10694 ABN 65 614 218 192


42 Dudley Street Pagewood, NSW 2035


CLIENT: Mr & Mrs Naguib


113 Woolcott Street Earlwood NSW 2206 DRAWING: DEEPSOIL PLAN

SCALE: 1:200, 1:100 @A3 DRAWING NO: REV: PLOTTED: 3/1/2022 [O] A07

All dimensions and floor areas are to verified by the Builder prior to commencement of any building work. Any discrepancies are to be torought to the attention of the designer. Levels shown are approximate unless accompanied by reduced levels. Figured dimensions must be taken in preference to scaling.

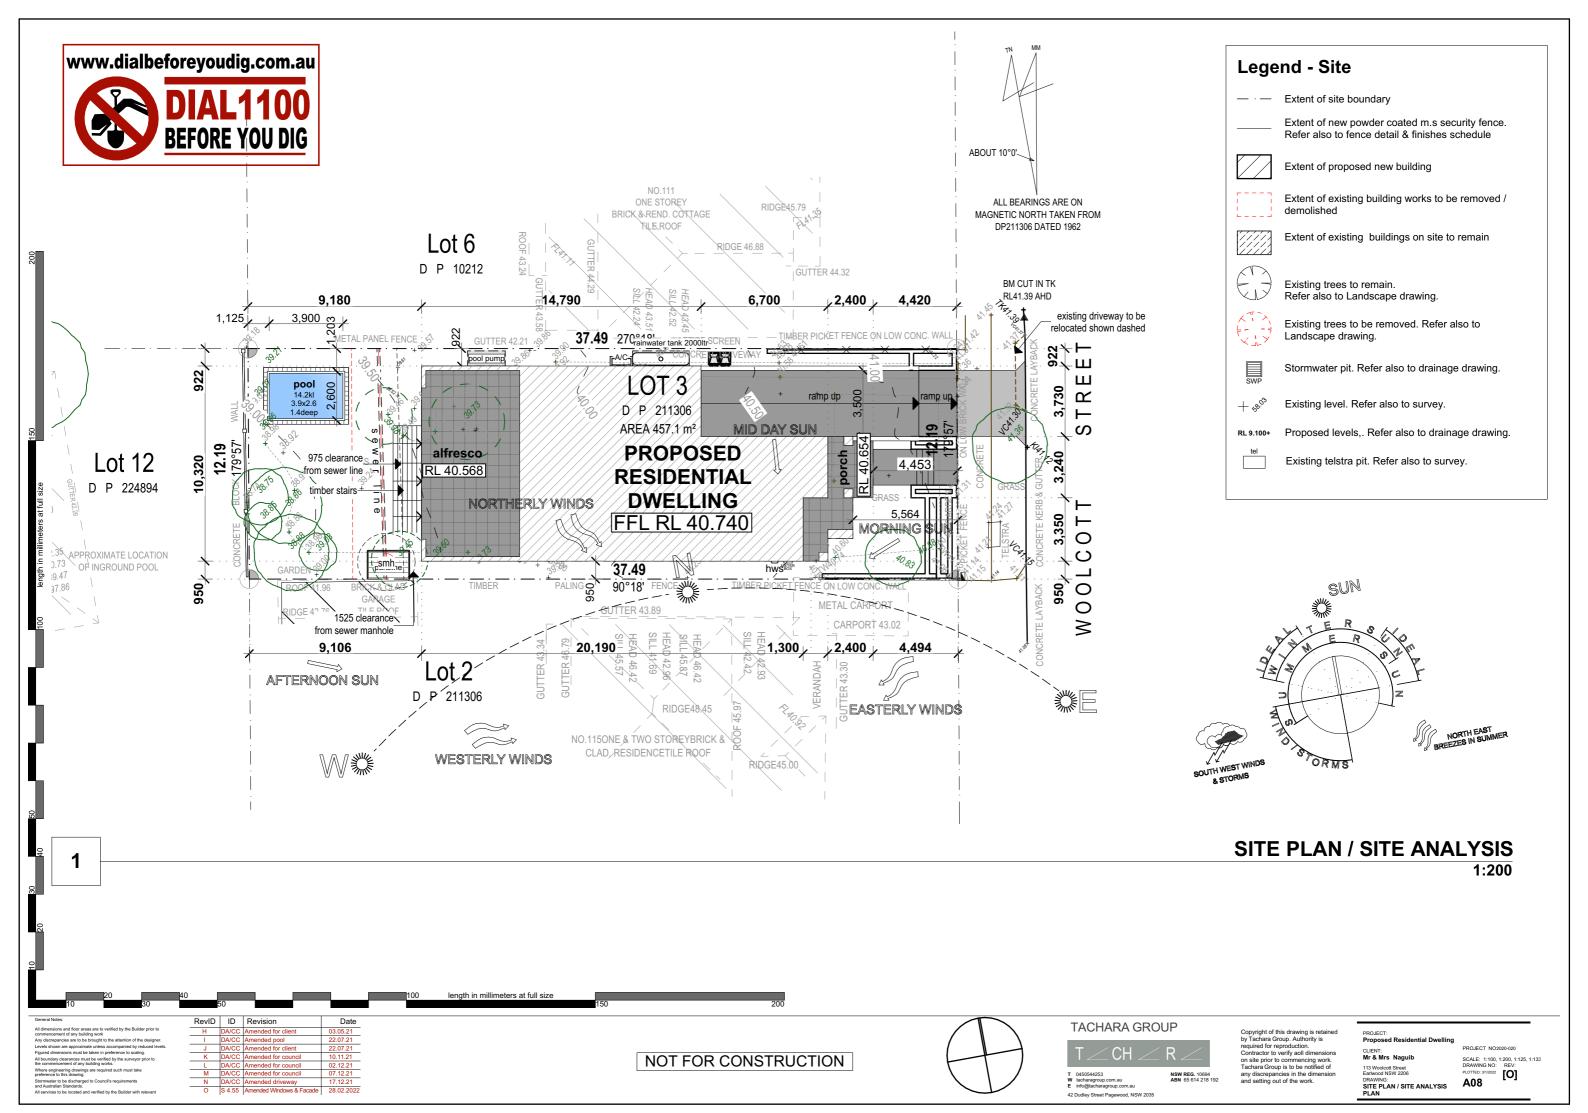

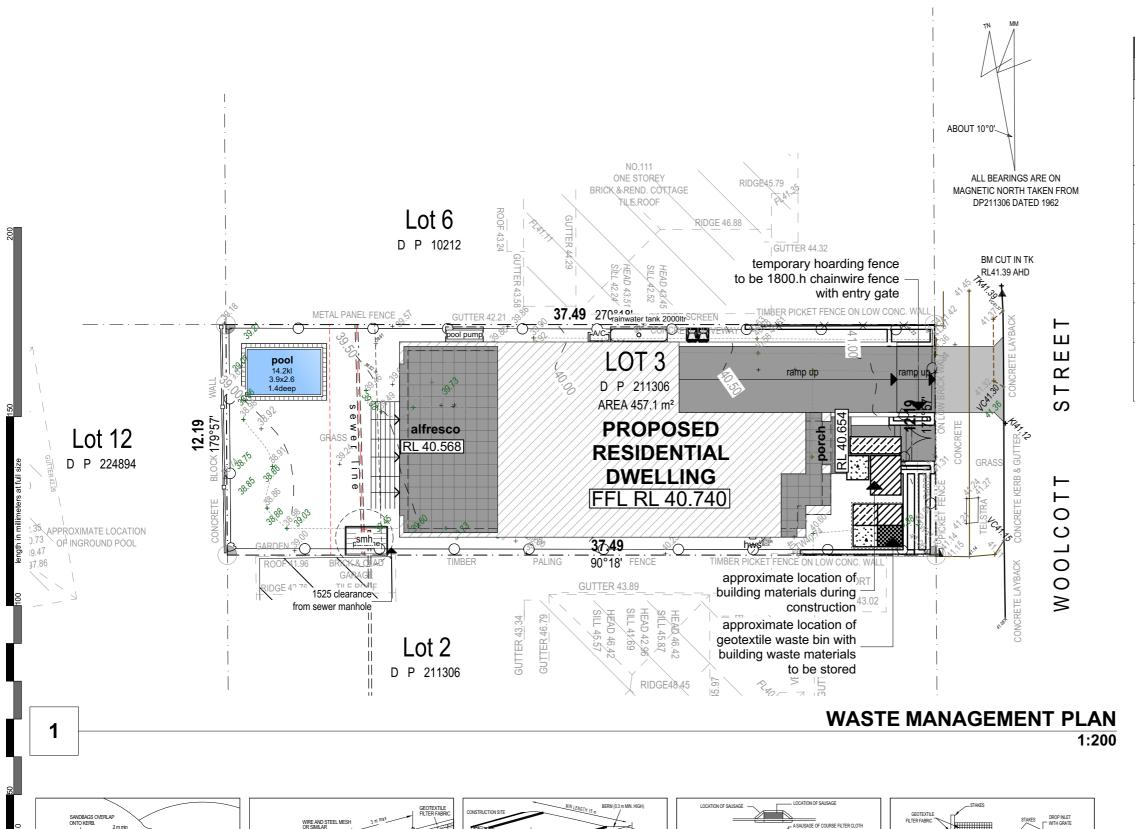

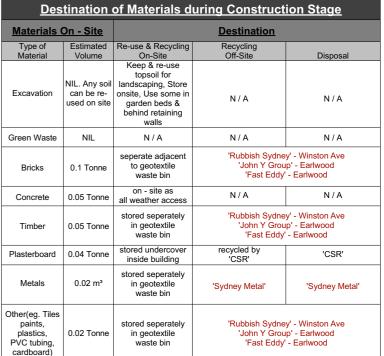



Materials



blockwork



concrete



steel




sand & other





excavation material


- 1. CONSTRUCTION MATERIAL TO BE STACKED AWAY FROM WASTE STREAMS TO ENSURE EASY ACCESS BY RECYCLING ORGANISATION, BUILDERS & SUB-CONTRACTORS.
- 2. CONSTRUCTION WASTE SEGREGATED INTO SEPARATE STREAMS (& STORED IN HOPPERS) .



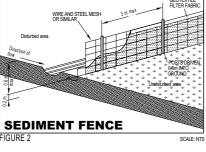

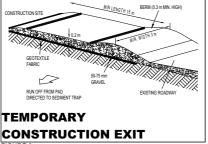

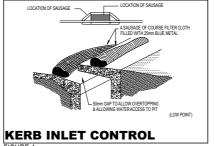

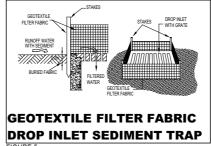

General Notes:	RevID	ID	Revision	Date
All dimensions and floor areas are to verified by the Builder prior to commencement of any building work	Н	DA/CC	Amended for client	03.05.21
Any discrepancies are to be brought to the attention of the designer.	1	DA/CC	Amended pool	22.07.21
Levels shown are approximate unless accompanied by reduced levels. Figured dimensions must be taken in preference to scaling.	J	DA/CC	Amended for client	22.07.21
All boundary clearances must be verified by the surveyor prior to	K	DA/CC	Amended for council	10.11.21
the commencement of any building works.	L	DA/CC	Amended for council	02.12.21
Where engineering drawings are required such must take preference to this drawing.	M	DA/CC	Amended for council	07.12.21
Stormwater to be discharged to Council's requirements and Australian Standards	N	DA/CC	Amended driveway	17.12.21
All carries to he located and verified by the Builder with relevant	0	S 4.55	Amended Windows & Facade	28.02.202




TACHARA GROUP




required for reproduction.
Contractor to verify all dimens
on site prior to commencing we
Tachara Group is to be notified
any discrepancies in the dimen

PROJECT:
Proposed Residential
ons
CLIENT:
Mr & Mrs Naguib



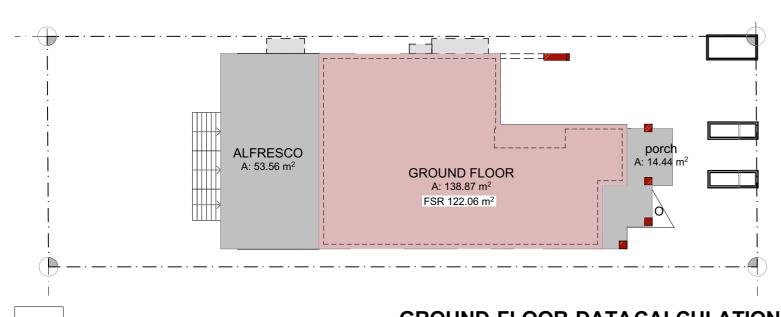

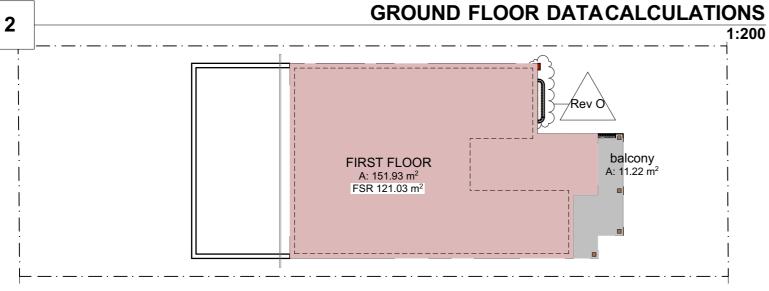

LEVEL 1 DATA CALCULATIONS

1:200

<u>SITE DATA</u>						
Zone	Name	m²				
001	SITE AREA	457.07				
002	LANDSCAPED AREA	174.26				
003	SITE COVERAGE	150.41				
004	IMPERMEABLE SURFACE	78.89				

Development Data

Zone	Name	m²
01	GROUND FLOOR	138.87
02	FIRST FLOOR	151.93
03	ALFRESCO	53.56
04	PORCH	14.44
06	BALCONY	11.22

370.02 m²

DEVELOPMENT	<u>DATA</u>
Site Area: Ground Floor Area:	457.07m ² 138.87m ²
First Floor Area:	151.93m²
Porch:	14.44m²

Balcony: 11.22m² Laundry 1.99m² 4.65m² Basement Stair **Basement Toilet** 1.33m² Alfresco: 53.56m² 377.99m² Total Area:

Total Floor Area: 251.06m² (Inside face of external walls,less void, porch, balconies & garage)

FSR Permitted 0.55:1 FSR: 0.55:1

RevID	ID	Revision	Date
0 ₽ - W (P	01	Issued for DA/CC S4.55 Issued for DA/CC	2000 rR0in Progress
D	DA/CC	Issued for DA/CC	21.01.21
Е	DA/CC	Issued for DA/CC	25.01.21
F	DA/CC	Amended Bathroom	22.02.21
G	DA/CC	Amended Door Heights	26.02.21
Н	DA/CC	Amended for client	03.05.21
- 1	DA/CC	Amended Pool	22.07.21
J	DA/CC	Amended for client	22.07.21
K	DA/CC	Amended for council	10.11.21
L	DA/CC	Amended for council	02.12.21
М	DA/CC	Amended for council	07.12.21
N	DA/CC	Amended driveway	17.12.21
0	S 4.55	Amended Windows & Facade	28.02.22

NOT FOR CONSTRUCTION



TACHARA GROUP




42 Dudley Street Pagewood, NSW 2035


CLIENT: Mr & Mrs Naguib


DEVELOPMENT DATA
CALCULATIONS


SCALE: 1:200, 1:1, 1:100, 1:8: DRAWING NO: REV: PLOTTED: 3/1/2022 [O] A10


NSW REG. 10694 ABN 65 614 218 192

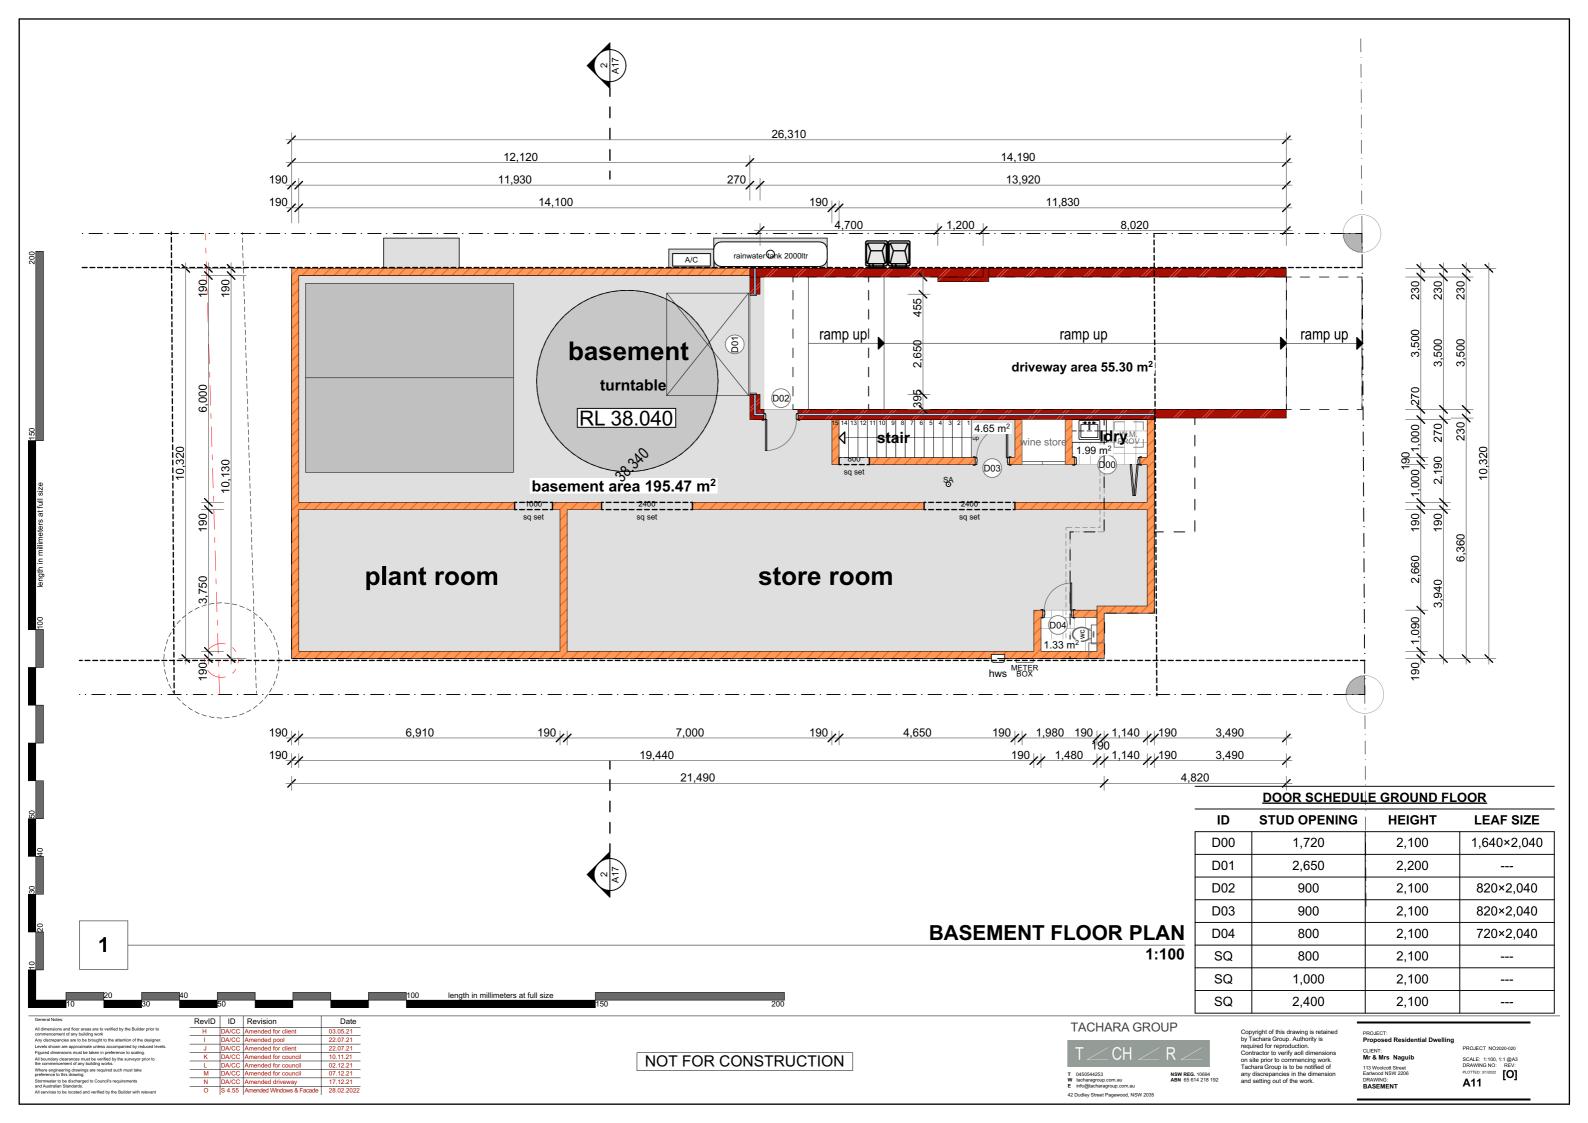


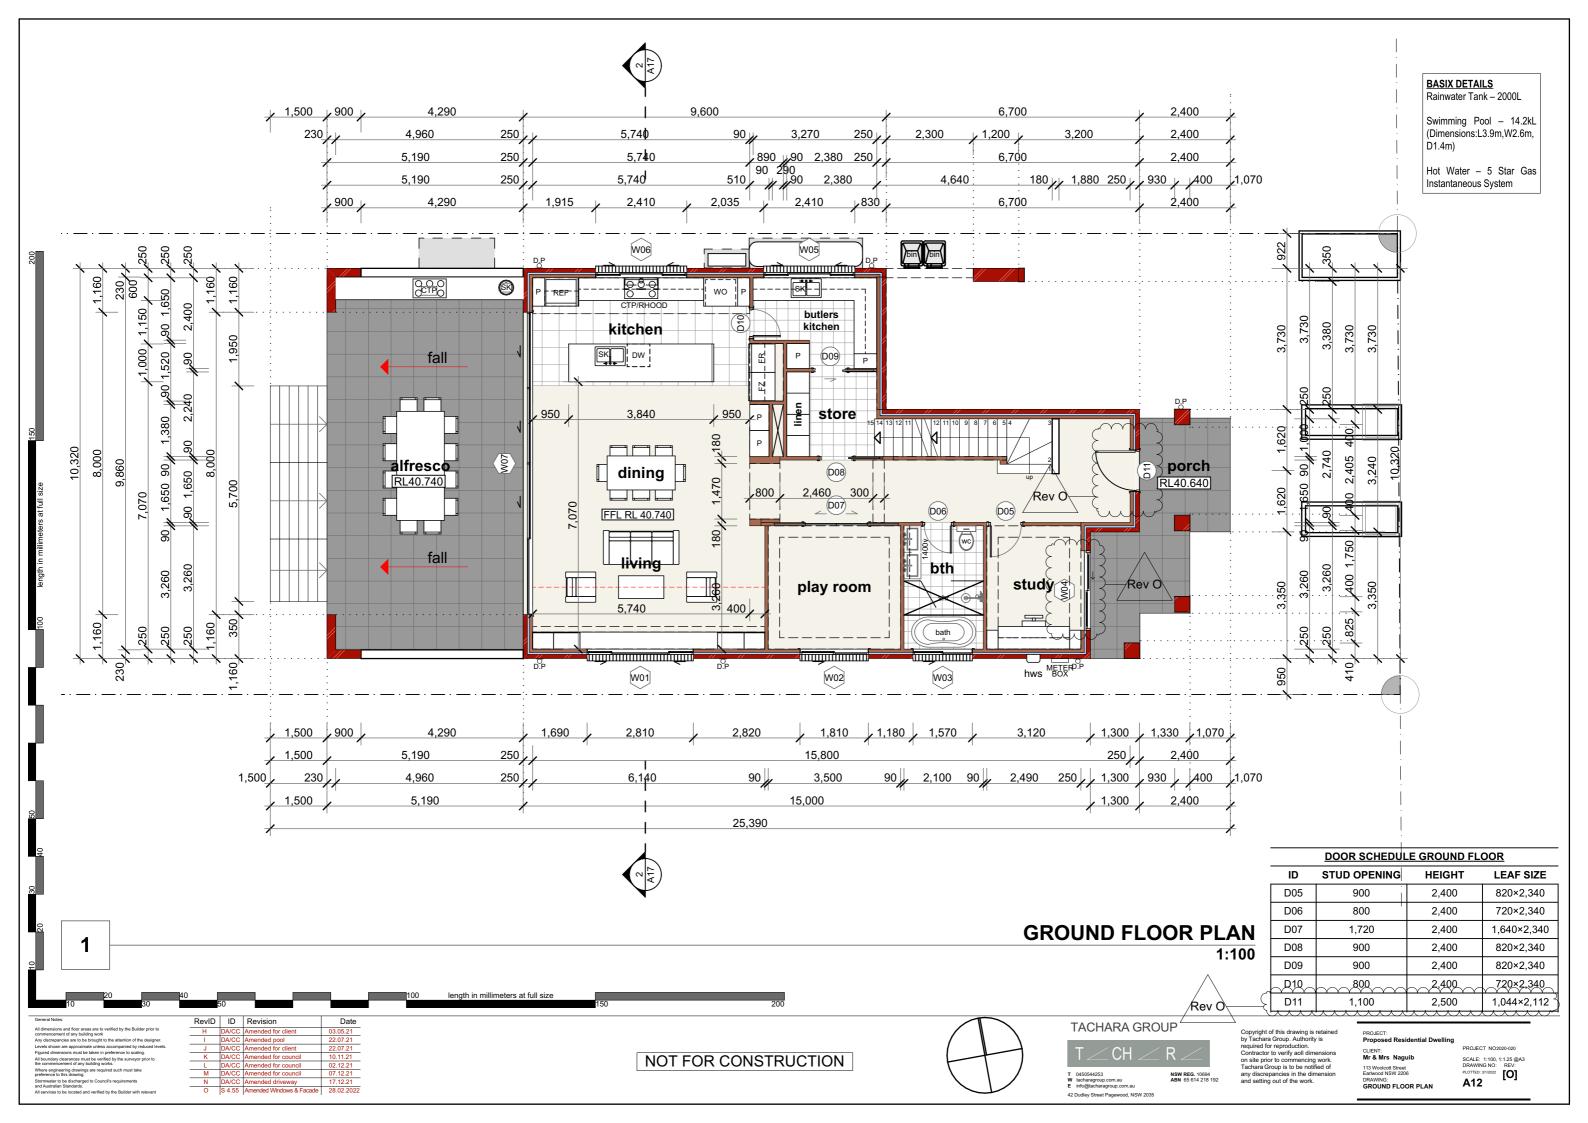


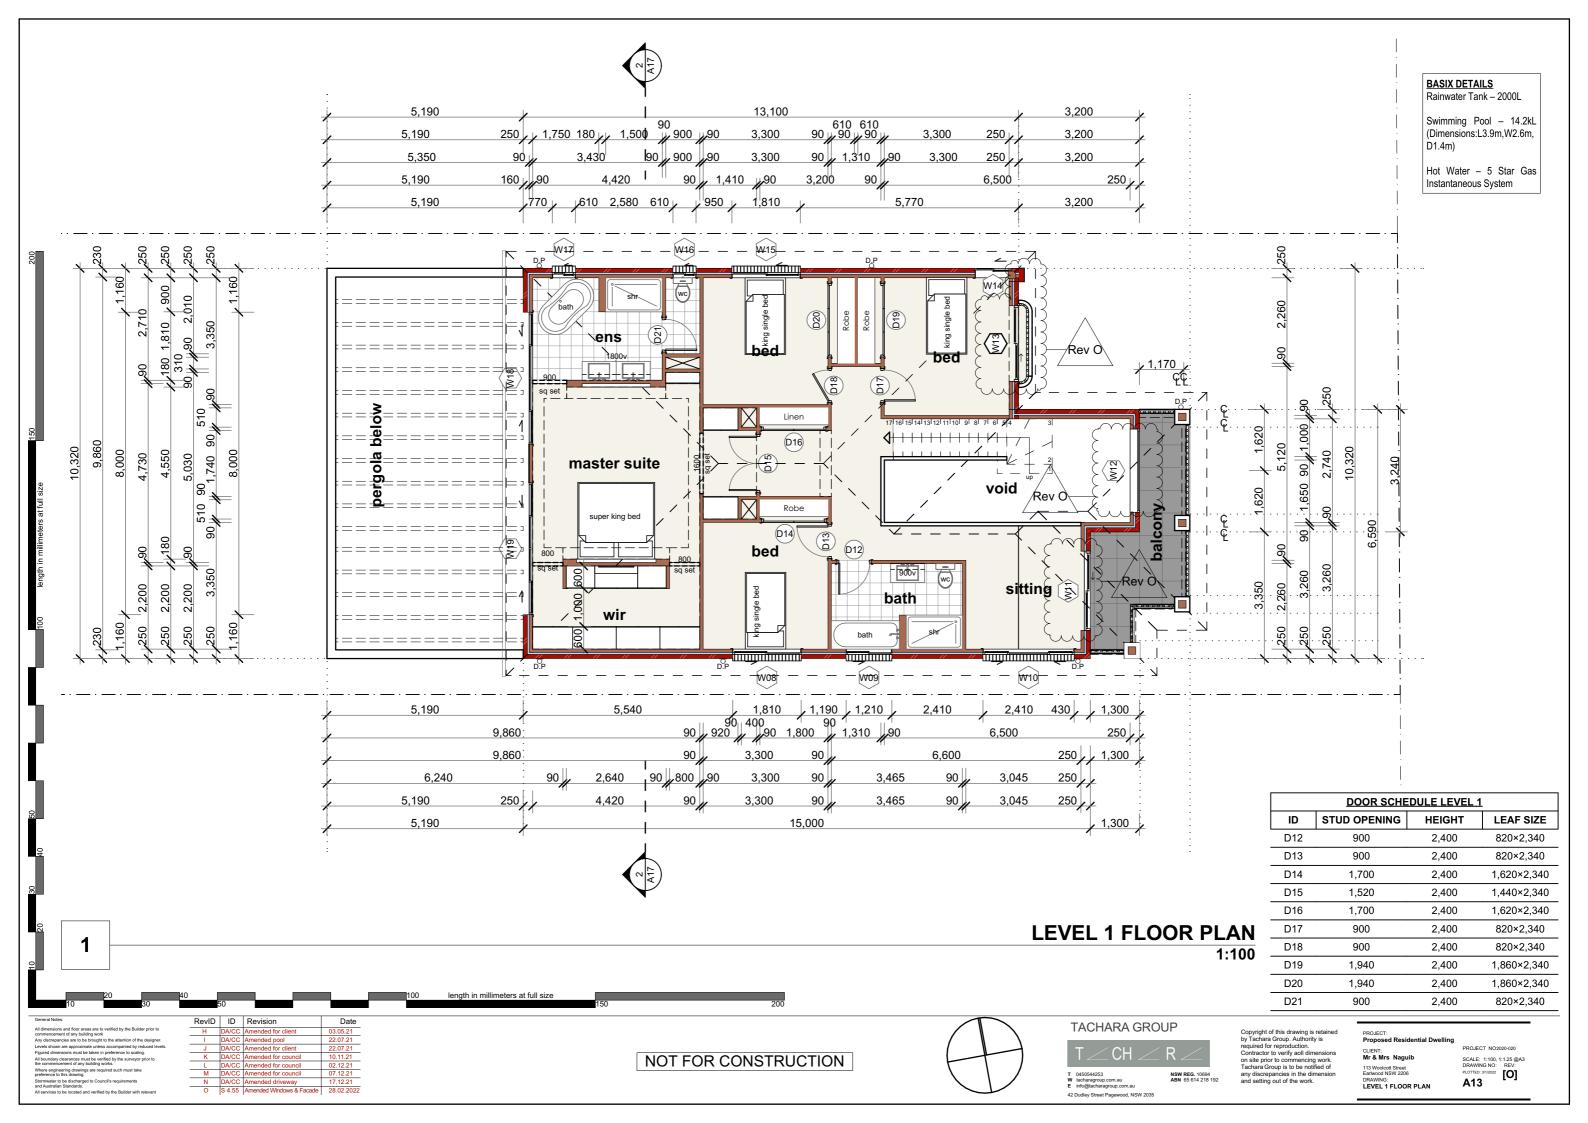


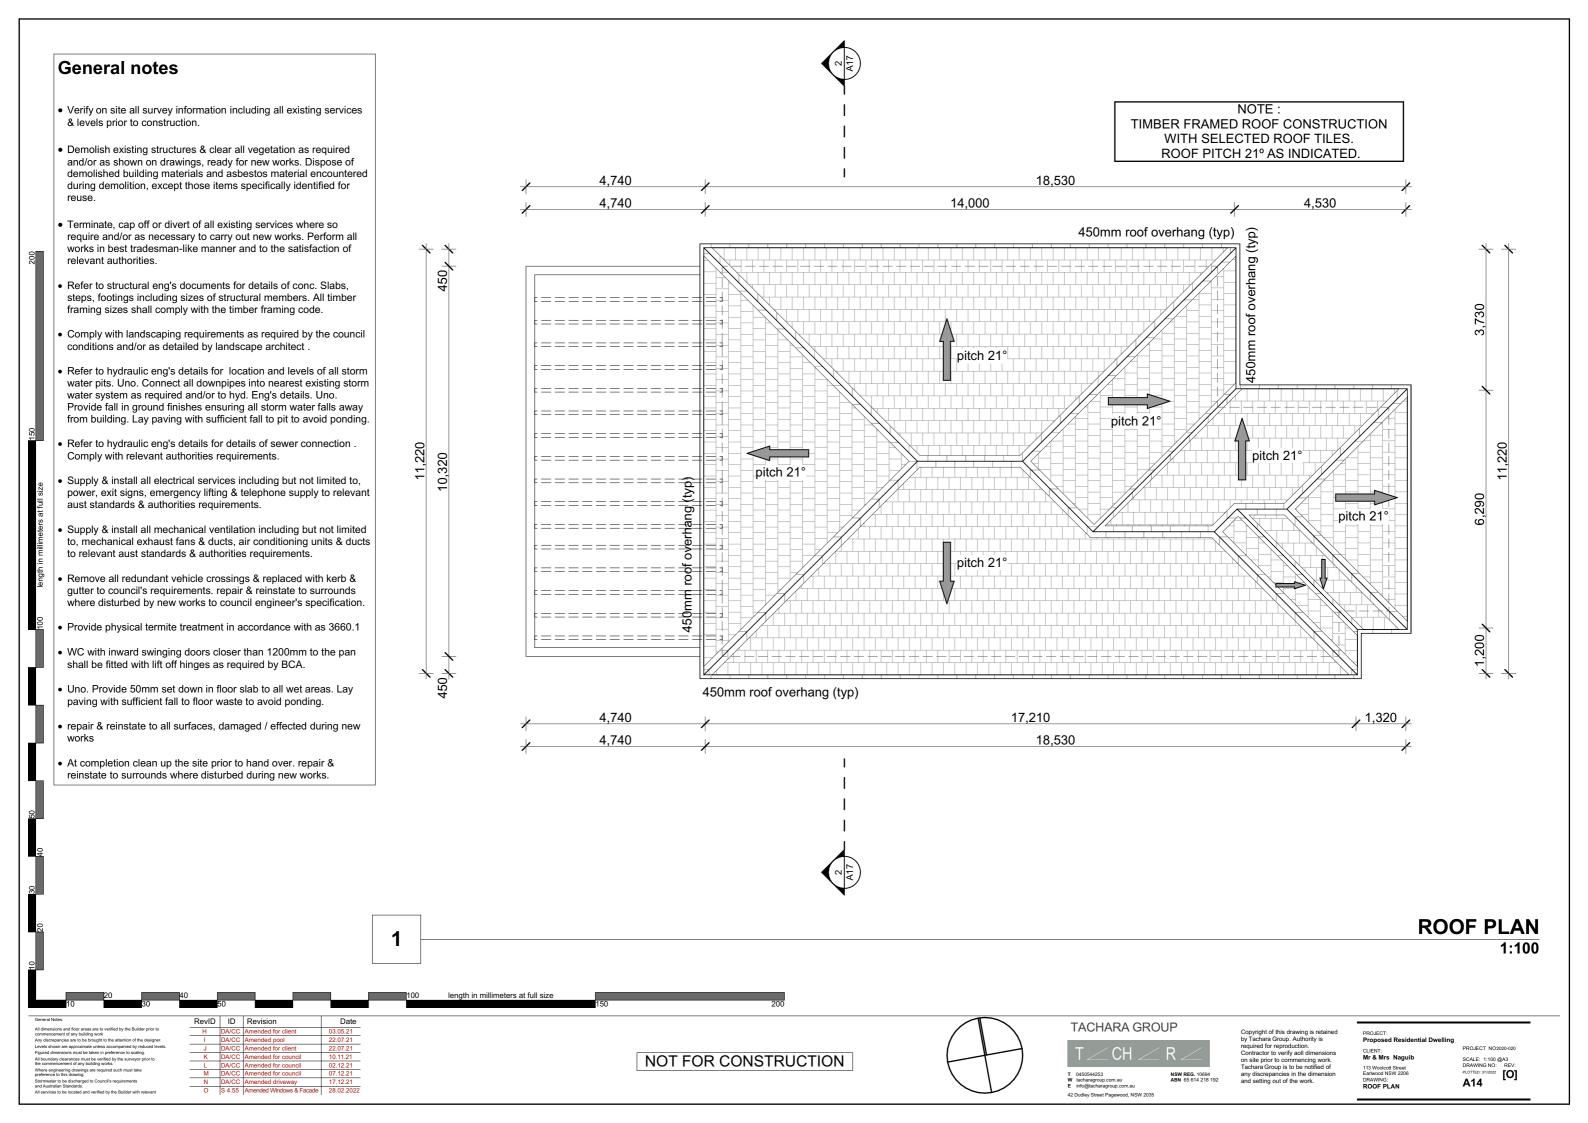


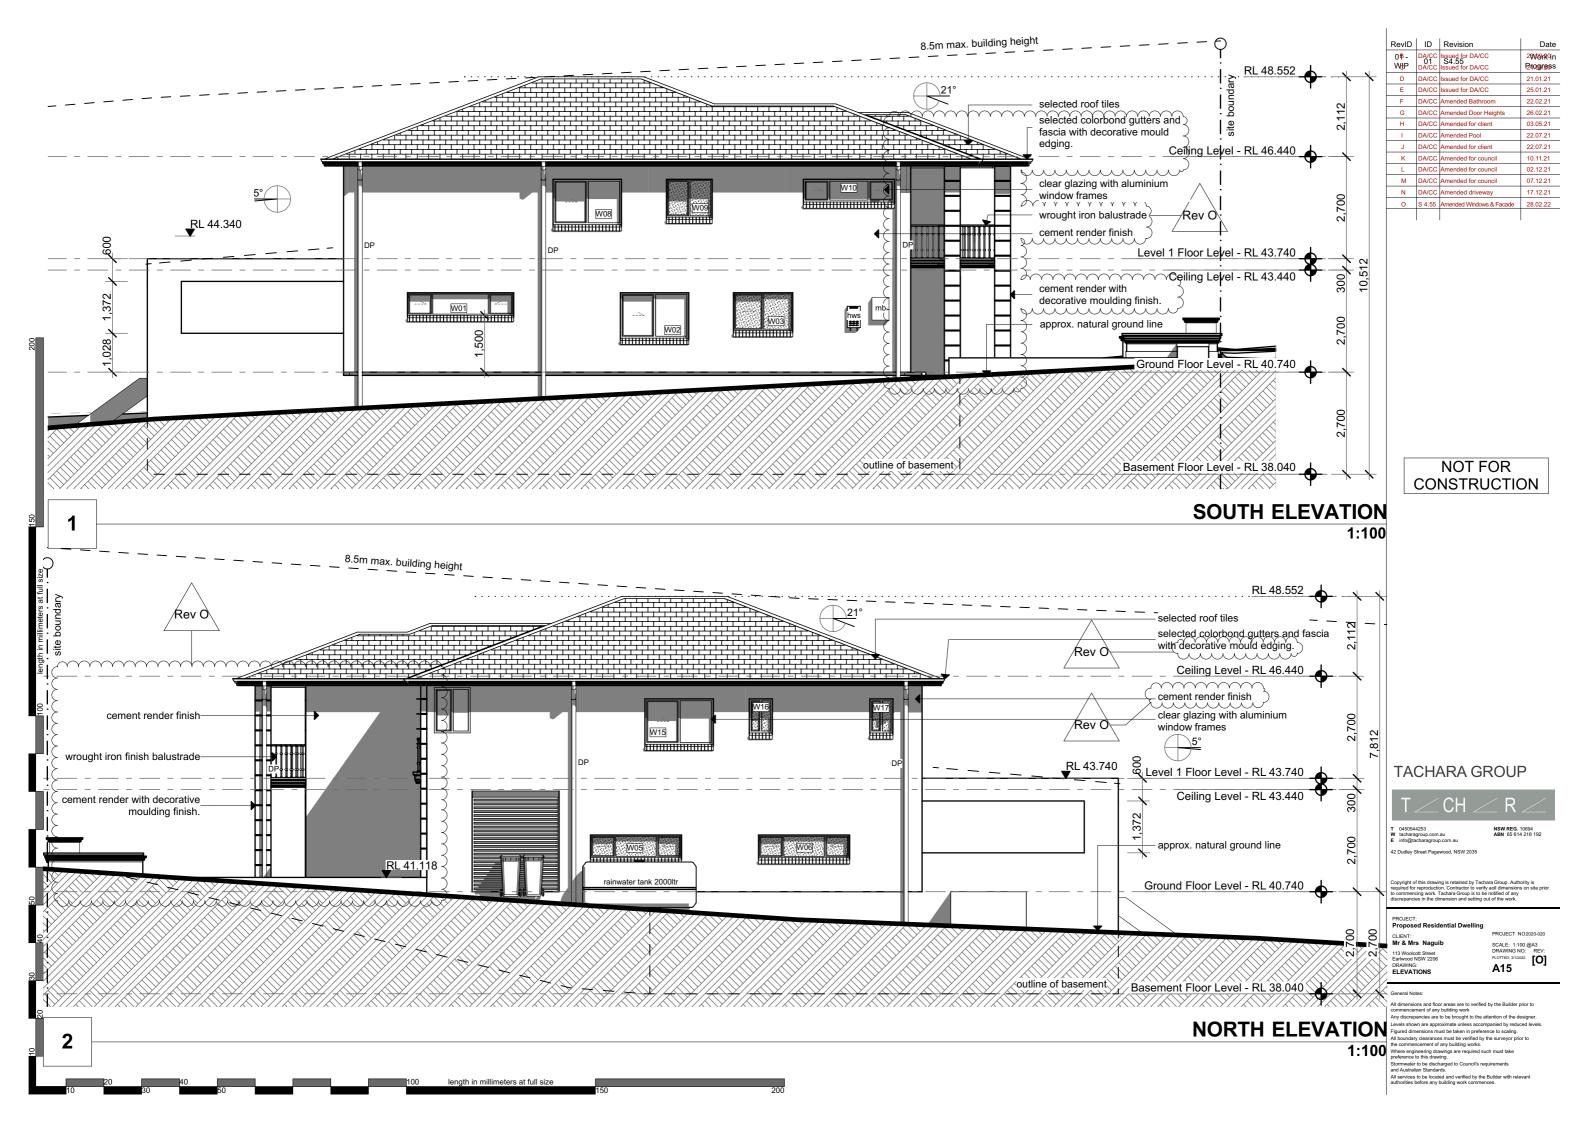


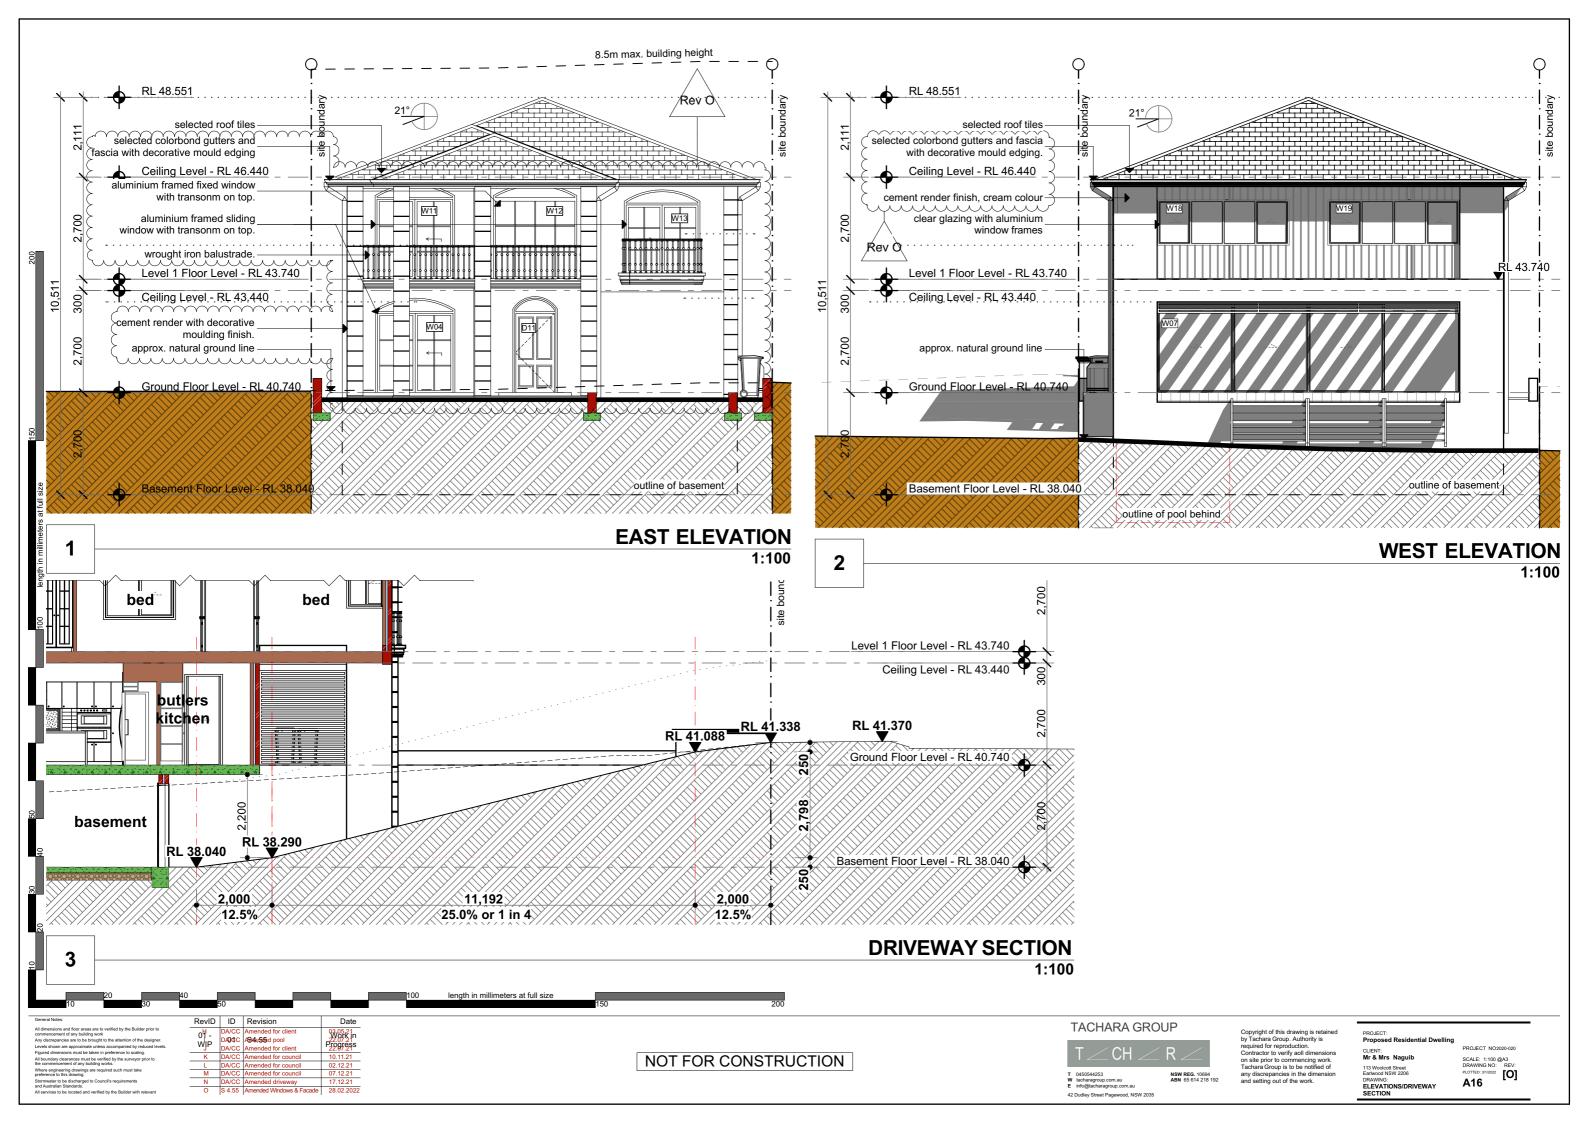


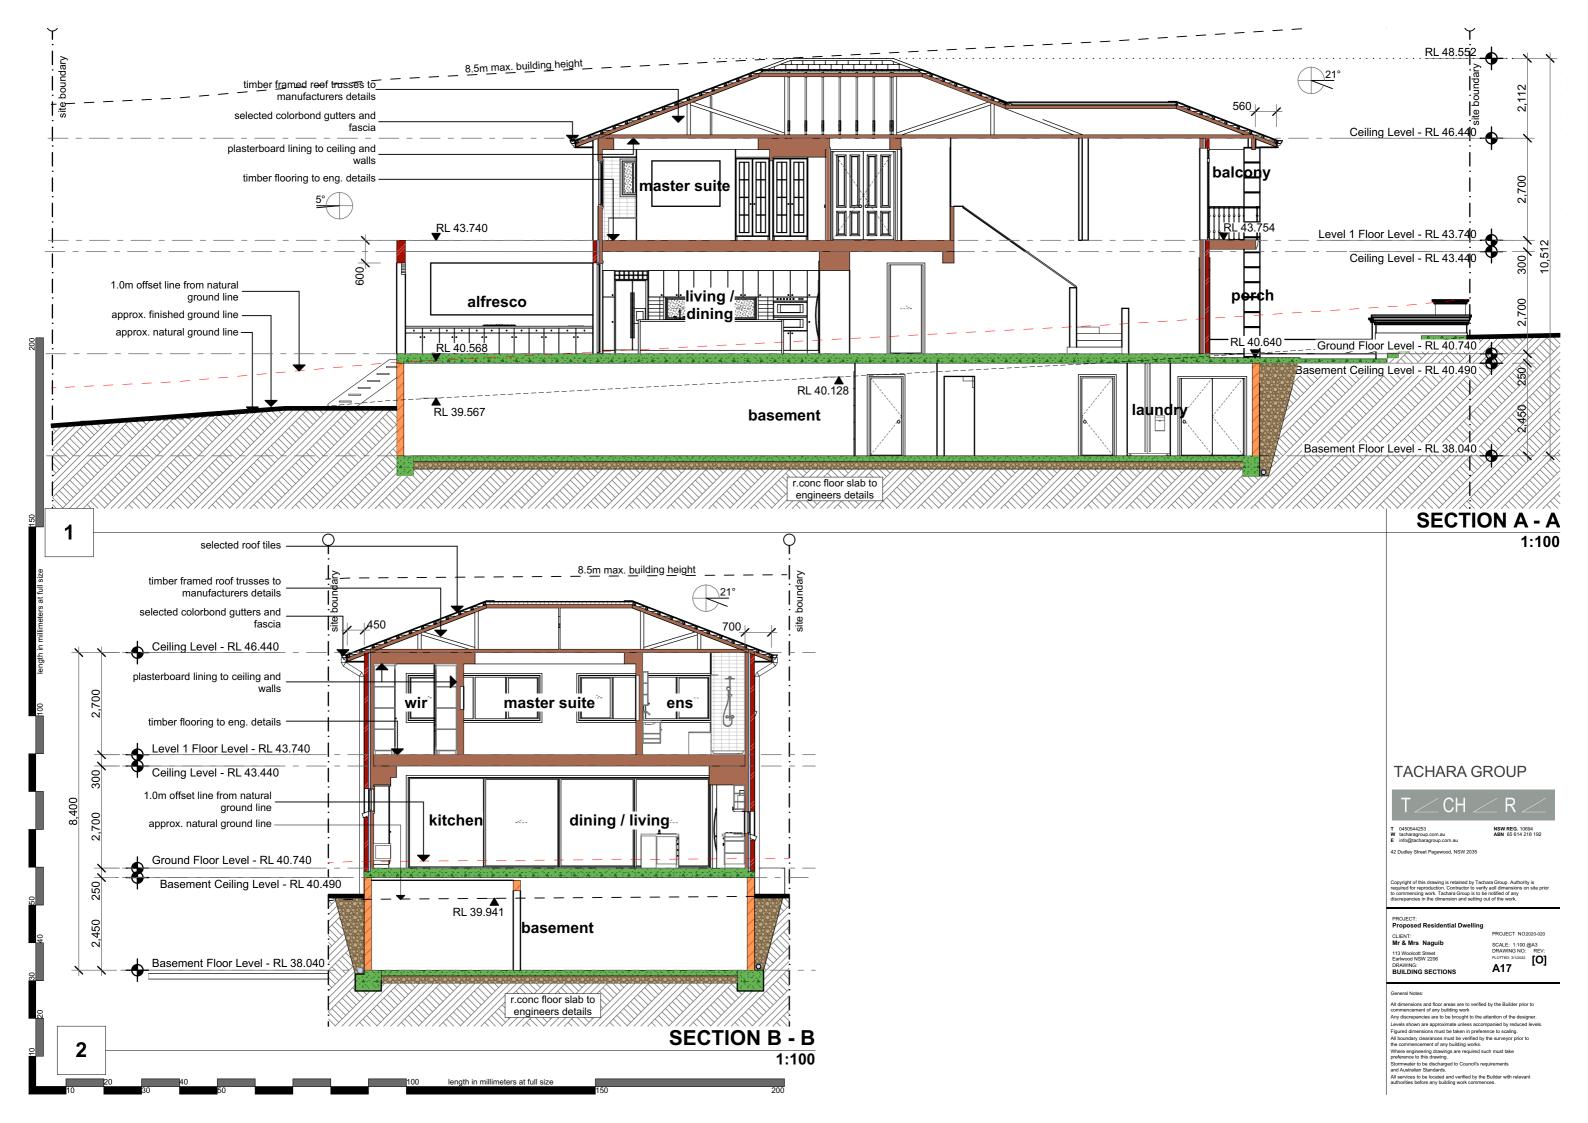


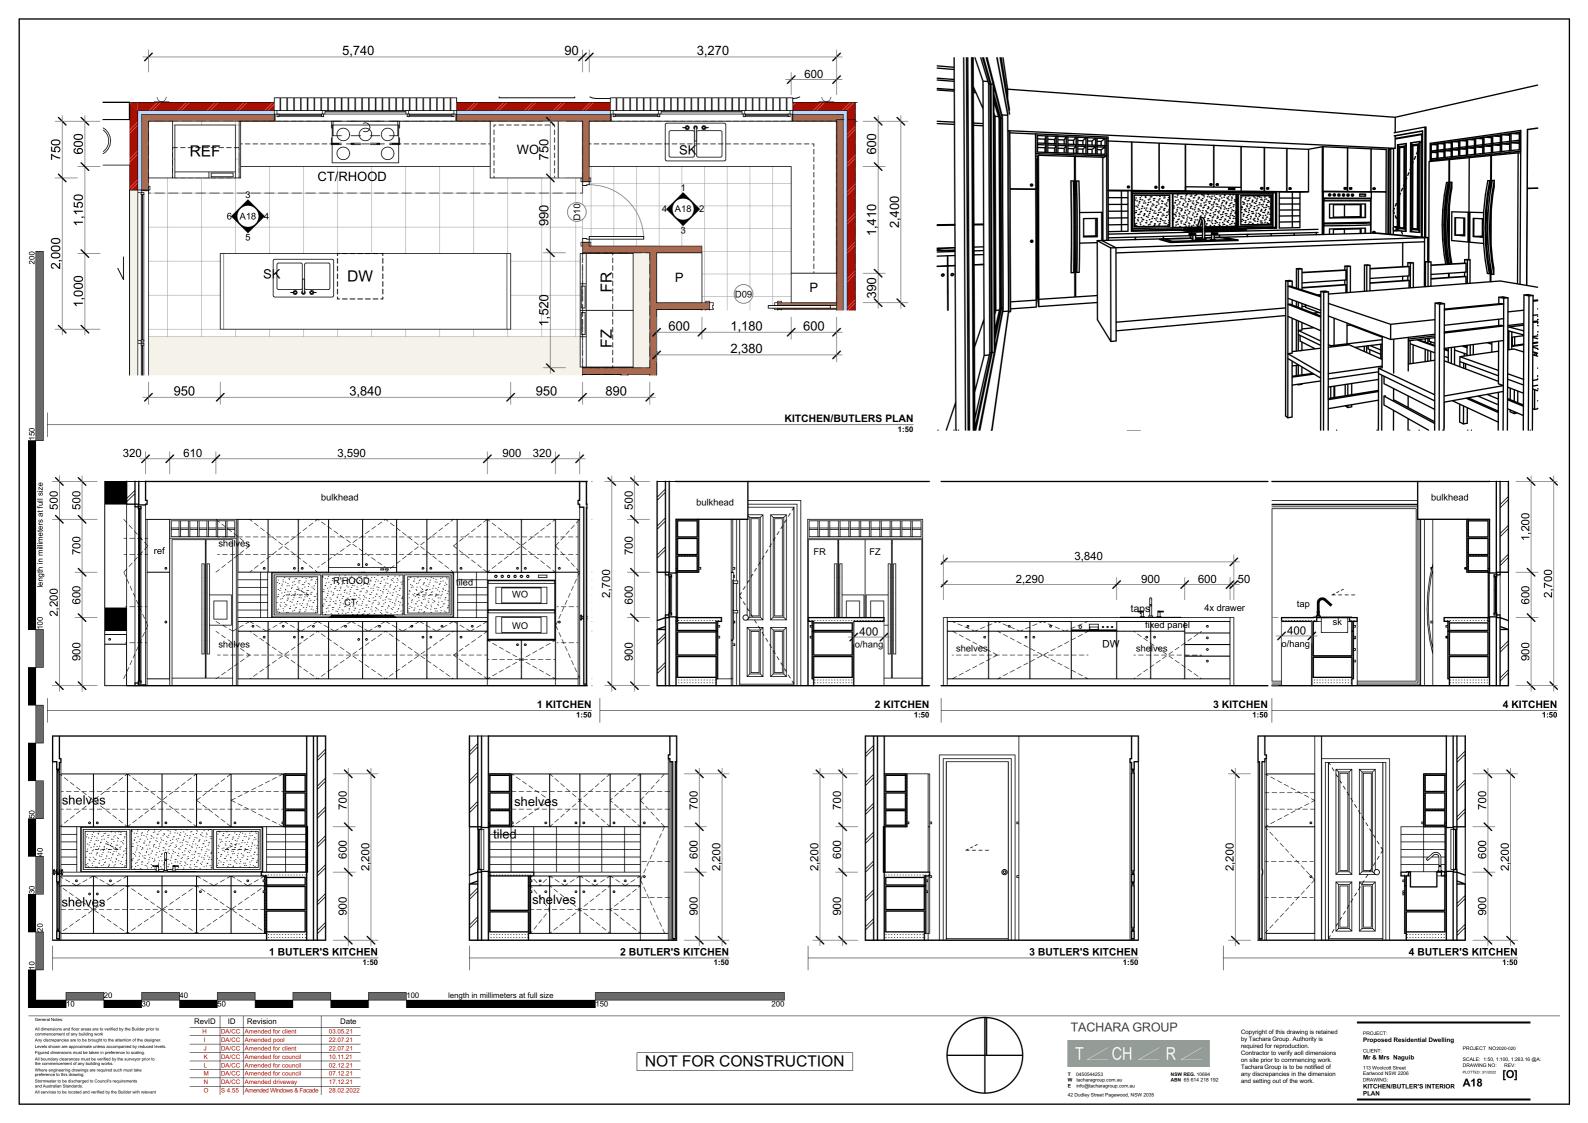


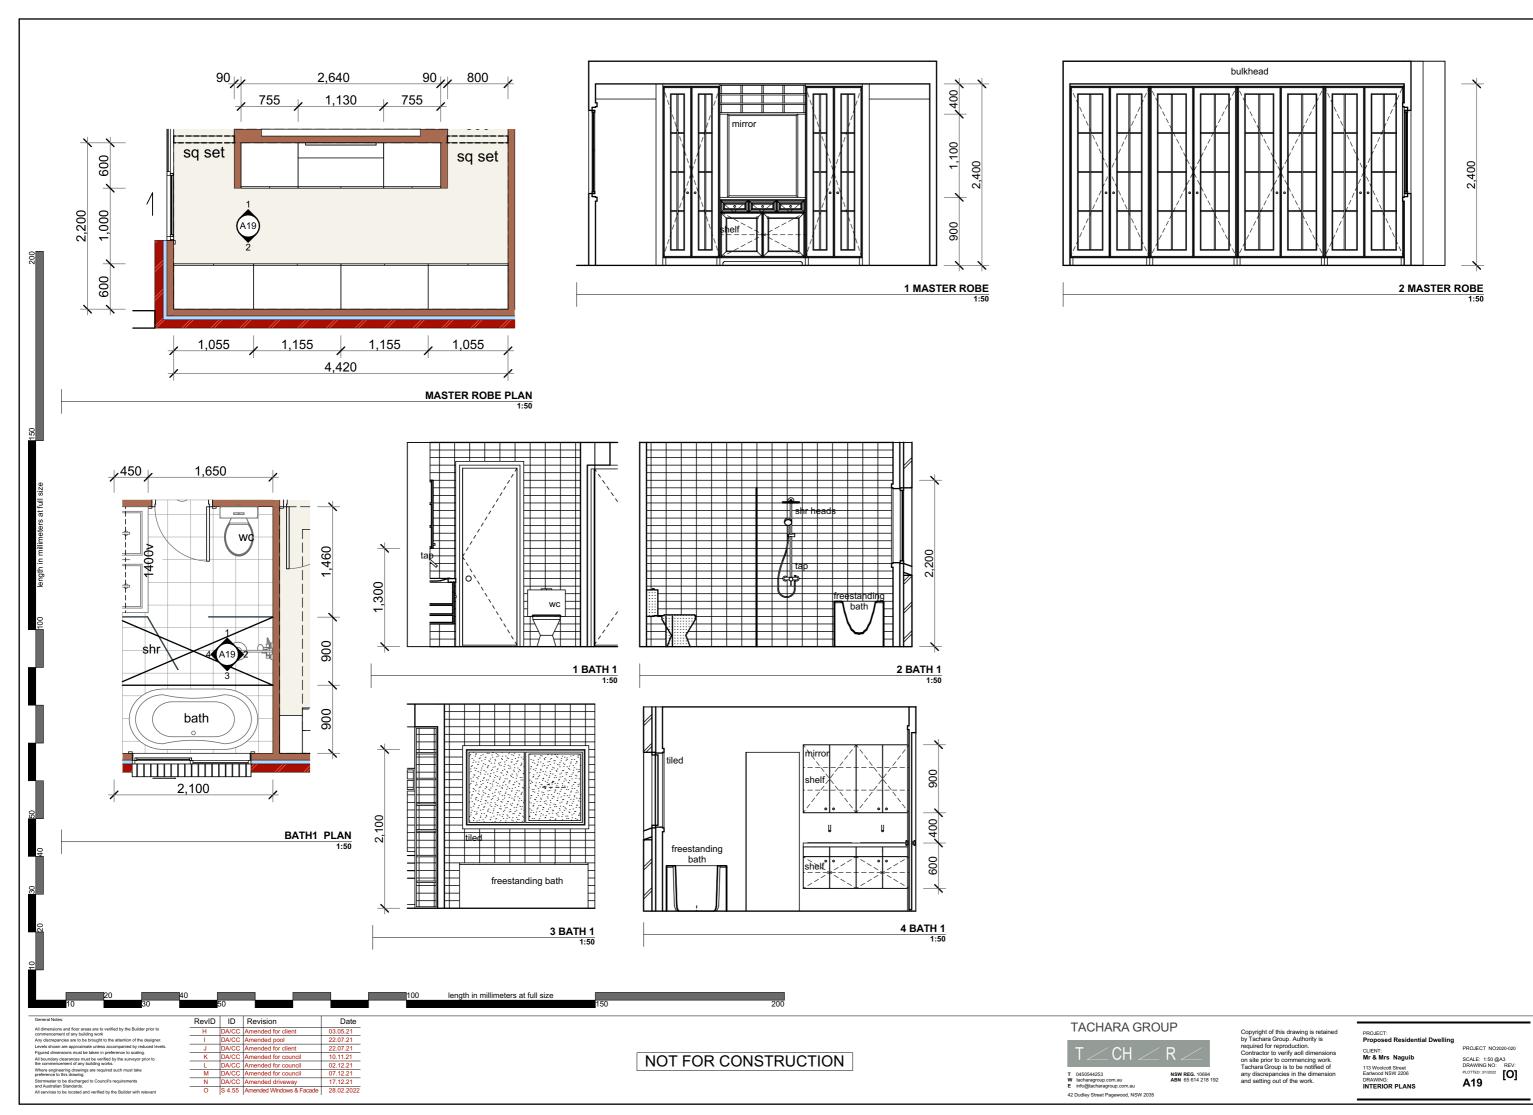


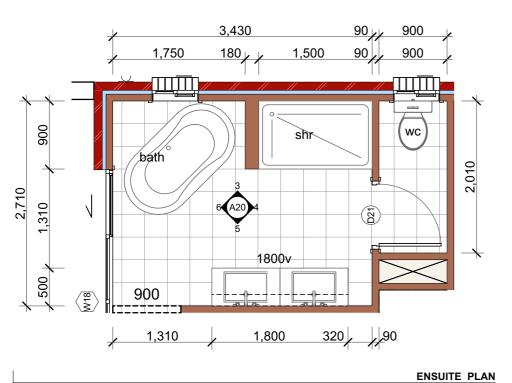

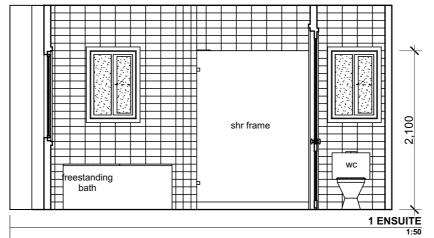


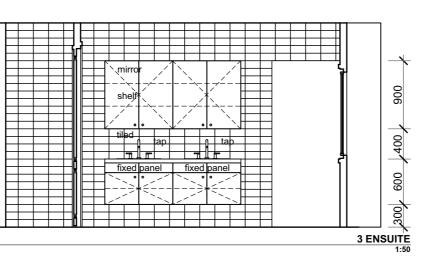


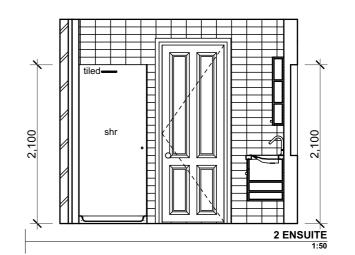


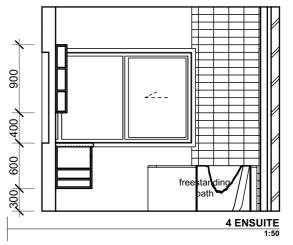





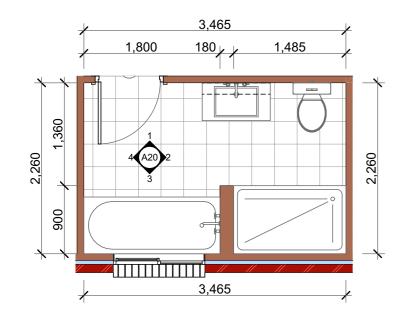


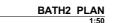


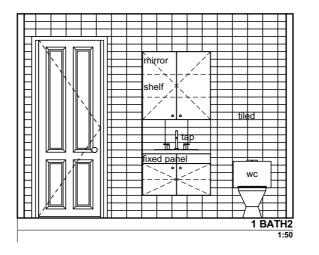

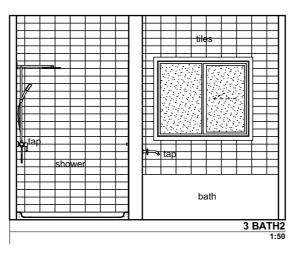

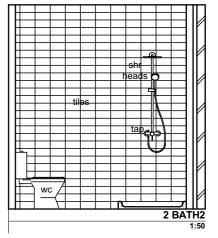

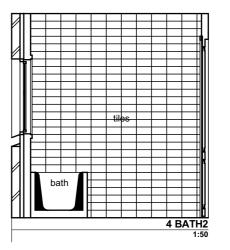

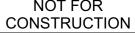

RevID ID Revision

J DA/CC Amended for client

K DA/CC Amended for council

M DA/CC Amended for council

O S 4.55 Amended Windows & Facade 28.02.22

Date

21.01.21

22.02.21

26.02.21 03.05.21 22.07.21

22.07.21

10.11.21 02.12.21

07.12.21

17.12.21



TACHARA GROUP



42 Dudley Street Pagewood, NSW 2035


CLIENT: Mr & Mrs Naguib SCALE: 1:50, 1:100 @A3 DRAWING NO: REV: PLOTTED: 3/1/2022 [O] 113 Woolcott Street Earlwood NSW 2206 DRAWING:

A20

INTERIOR PLANS

All dimensions and floor areas are to verified by the Builder prior to commencement of any building work. Any discrepancies are to be brought to the attention of the designer. Levels shown are approximate unless accompanied by reduced levels.

All services to be located and verified by the Builder with relevan authorities before any building work commences.

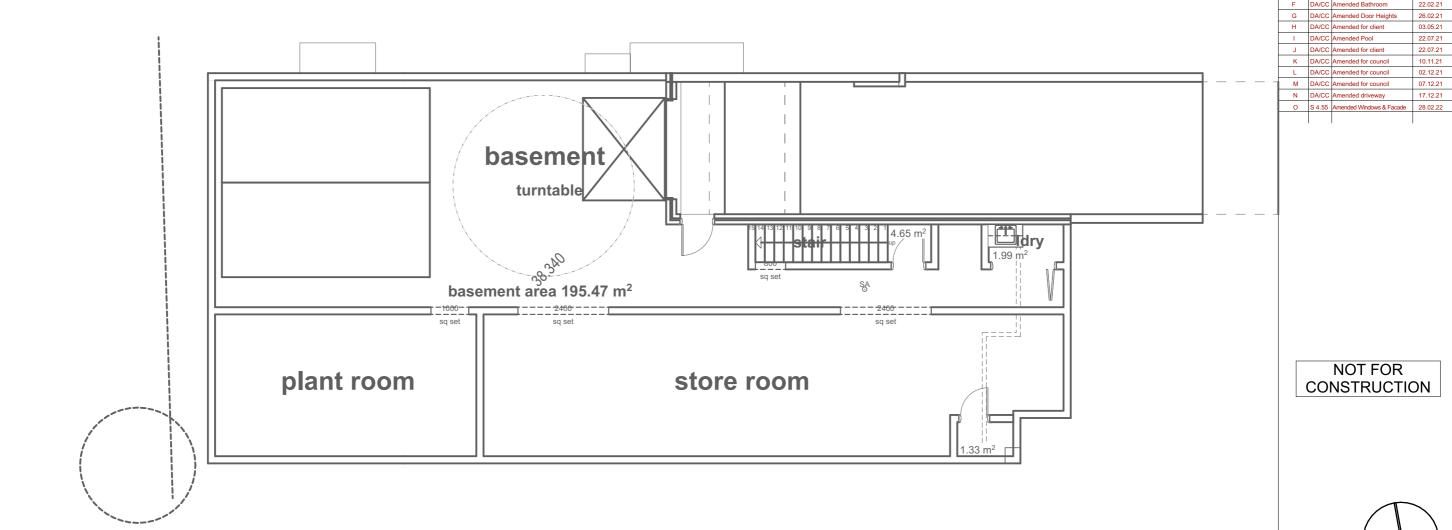

BASEMENT ELECTRICAL PLAN 1:100

RevID | ID | Revision

22.02.21 26.02.21 22.07.21 22.07.21 10.11.21 02.12.21 07.12.21 17.12.21

ELECTRICAL SCHEDULE O CEILING LIGHT TWO WAY LIGHT SWITCH 0 NBN CONNECTION POINT CEILING LIGHT FAN © COMPACT FLUORESCENT LIGHT THREE WAY LIGHT SWITCH 0 AUDIO SPEAKER **CEILING FAN** 0 WALL LIGHT (Junction Box) GAS BAYONET POINT WATER PROOF DPP 0 DATA POINT WIRED SMOKE DETECTOR (FINAL POSITION TO BE DETERMINED ON SIT 0 NO DOWNLIGHTS (10W LED COOL LIGHT) 3 PHASE POWER TO MB. 0 NO DOUBLE FLUORESCENT → CEILING EXHAUST FAN UPGRADE EXISTING HOUSE MB. **■** DOUBLE POWER POINT IXL CEILING EXHAUST FAN (IXL2 - 2 HEATER LIGHT) (IXL4 - 4 HEATER LIG 0 SINGLE FLUORESCENT SINGLE POWER POINT (INCL. RANGE HOOD, DISHWASHER, REFRIGERATOR x 2, DATANETWORK & GARAGE DOOR) CIRCULAR FLUORESCENT 0 TELEPHONE POINT (WS - WALL SOCKET) (FS - FLOOR SO FLOOD LIGHT 0 , **~** _ **,** WIRING TELEVISION POINT (TV - FREE TO AIR) (PT - PAY TV)

1

TACHARA GROUP

	J / D
ı	7 / K /

42 Dudley Street Pagewood, NSW 2035

NSW REG. 10694 ABN 65 614 218 192

SCALE: 1:100, 1:50 @A3
DRAWING NO: REV:
PLOTTED: 3/1/2022 [O]
A21

CLIENT: Mr & Mrs Naguib

BASEMENT FLOOR



GROUND FLOOR ELECTRICAL PLAN

1:100

	ELECTRICAL SCHEDULE								
	O CEILING LIGHT	0	2W TWO WAY LIGHT SWITCH	0	■	NBN CONNECTION POINT	0	CEILING LIGHT FAN	0
20	© COMPACT FLUORESCENT LIGHT (0	3W THREE WAY LIGHT SWITCH	0	f	AUDIO SPEAKER	0	CEILING FAN	0
0	WALL LIGHT (Junction Box) (WL: WALL LIGHT, SL: STEP LIGHT, & JB: JUNCTION BOX)	0	₩ WATER PROOF DPP	0	여	GAS BAYONET POINT (GAS - INTERNAL) (BBQ - EXTERNAL)	0	■ DATA POINT	0
4	DOWNLIGHTS (10W LED COOL LIGHT)	0	^{№°} Q WATER PROOF SPP	0	(§)	WIRED SMOKE DETECTOR (FINAL POSITION TO BE DETERMINED ON SITE)	0	3 PHASE POWER TO MB.	NO
30	DOUBLE FLUORESCENT (0	■ DOUBLE POWER POINT	0	Ф	CEILING EXHAUST FAN	0	UPGRADE EXISTING HOUSE MB.	NO
	SINGLE FLUORESCENT	0	■ SINGLE POWER POINT	0	•	IXL CEILING EXHAUST FAN (IXL2 - 2 HEATER LIGHT) (IXL4 - 4 HEATER LIGHT)	0		
20	CIRCULAR FLUORESCENT (0	(INCL. RANGE HOOD, DISHWASHER, REFRIGERATOR x 2, DATA NETWORK & GARAGE DOOR)	0					\Box
0		0	TELEPHONE POINT (WS-WALL SOCKET) (FS-FLOOR SOCKET)	0				, — _ , WIRING	
7			TELEVISION POINT (TV - FREE TO AIR) (PT - PAY TV)	0					

1

RevID	ID	Revision	Date
0 ₽ - W&P	01	Issued for DA/CC S4.55 Issued for DA/CC	2000 ork ^o in Puogr <u>e</u> ss
D	DA/CC	Issued for DA/CC	21.01.21
E	DA/CC	Issued for DA/CC	25.01.21
F	DA/CC	Amended Bathroom	22.02.21
G	DA/CC	Amended Door Heights	26.02.21
Н	DA/CC	Amended for client	03.05.21
1	DA/CC	Amended Pool	22.07.21
J	DA/CC	Amended for client	22.07.21
К	DA/CC	Amended for council	10.11.21
L	DA/CC	Amended for council	02.12.21
М	DA/CC	Amended for council	07.12.21
N	DA/CC	Amended driveway	17.12.21
0	S 4.55	Amended Windows & Facade	28.02.22

NOT FOR CONSTRUCTION



TACHARA GROUP




42 Dudley Street Pagewood, NSW 2035

CLIENT: Mr & Mrs Naguib

mr & Mrs Naguib

SCALE: 1:100, 1:50 @A3

113 Woolcold Street
Earlwood NSW 2206
DRAWING:
GROUND FLOOR ELECTRICAL
PLAN

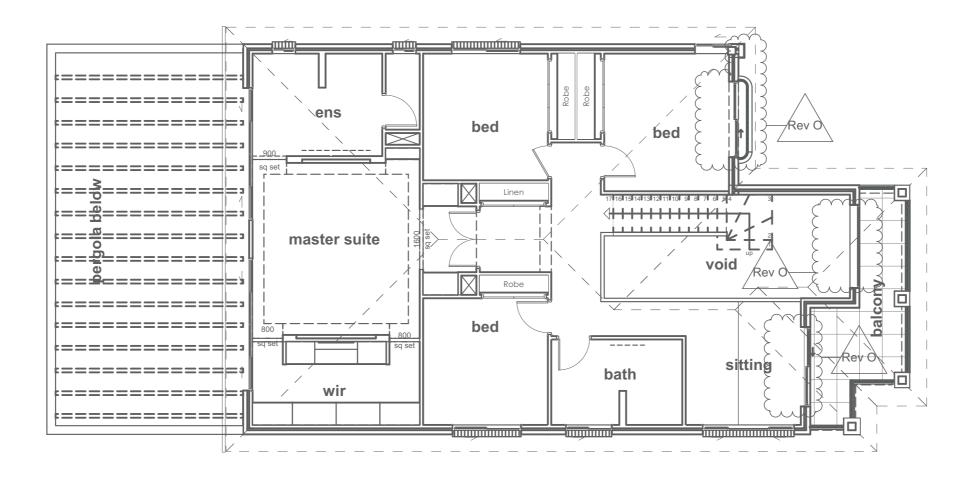

LEVEL 1 FLOOR ELECTRICAL PLAN 1:100

2

ELECTRICAL SCHEDULE										
	O CEILING LIGHT	0	2W	TWO WAY LIGHT SWITCH	0	(■ NBN CONNECTION POINT	0	CEILING LIGHT FAN 0	
8	© COMPACT FLUORESCENT LIGHT	0	3W	THREE WAY LIGHT SWITCH	0	ſ	AUDIO SPEAKER	0	CEILING FAN 0	
0	WALL LIGHT (Junction Box) (WL: WALL LIGHT, SL: STEP LIGHT, & JB: JUNCTION BOX)	0	^{N_bO}	WATER PROOF DPP	0	0	GAS BAYONET POINT (GAS - INTERNAL) (BBQ - EXTERNAL)	0	DATA POINT 0	
40	DOWNLIGHTS (10W LED COOL LIGHT)	0	^{1/6} 2 ⊕	WATER PROOF SPP	0	(WIRED SMOKE DETECTOR (FINAL POSITION TO BE DETERMINED ON SITE)	0	3 PHASE POWER TO MB. NO	
8	DOUBLE FLUORESCENT	0	22	DOUBLE POWER POINT	0	(CEILING EXHAUST FAN	0	UPGRADE EXISTING HOUSE MB. NO	
	SINGLE FLUORESCENT	0	Ð	SINGLE POWER POINT	0	•	IXL CEILING EXHAUST FAN (IXL2 - 2 HEATER LIGHT) (IXL4 - 4 HEATER LIGHT)	0		
50	CIRCULAR FLUORESCENT	0		(INCL. RANGE HOOD, DISHWASHER, REFRIGERATOR x 2, DATA NETWORK & GARAGE DOOR)	0					
		0	#	TELEPHONE POINT (WS - WALL SOCKET) (FS - FLOOR SOCKET)	0				, ~ _ /WIRING	
2			*	TELEVISION POINT (TV-FREE TO AIR) (PT-PAYTV)	0					

RevID	ID	Revision	Date	
0 ₽ - W&P	01	Issued for DA/CC S4.55 Issued for DA/CC	20W9rk0in Puogress	
D	DA/CC	Issued for DA/CC	21.01.21	
Е	DA/CC	Issued for DA/CC	25.01.21	
F	DA/CC	Amended Bathroom	22.02.21	
G	DA/CC	Amended Door Heights	26.02.21	
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J	DA/CC	Amended for client	22.07.21	
К	DA/CC	Amended for council	10.11.21	
L	DA/CC	Amended for council	02.12.21	
M	DA/CC	Amended for council	07.12.21	
N	DA/CC	Amended driveway	17.12.21	
0	S 4.55	Amended Windows & Facade	28.02.22	

NOT FOR CONSTRUCTION




TACHARA GROUP




42 Dudley Street Pagewood, NSW 2035

CLIENT: Mr & Mrs Naguib

SCALE: 1:50, 1:100 @A3 DRAWING NO: REV: PLOTTED: 3/1/2022 [O] 113 Woolcott Street DRAWNING: PLOTTED: 3/1/2/ DRAWNING: LEVEL 1 FLOOR ELECTRICAL PLAN

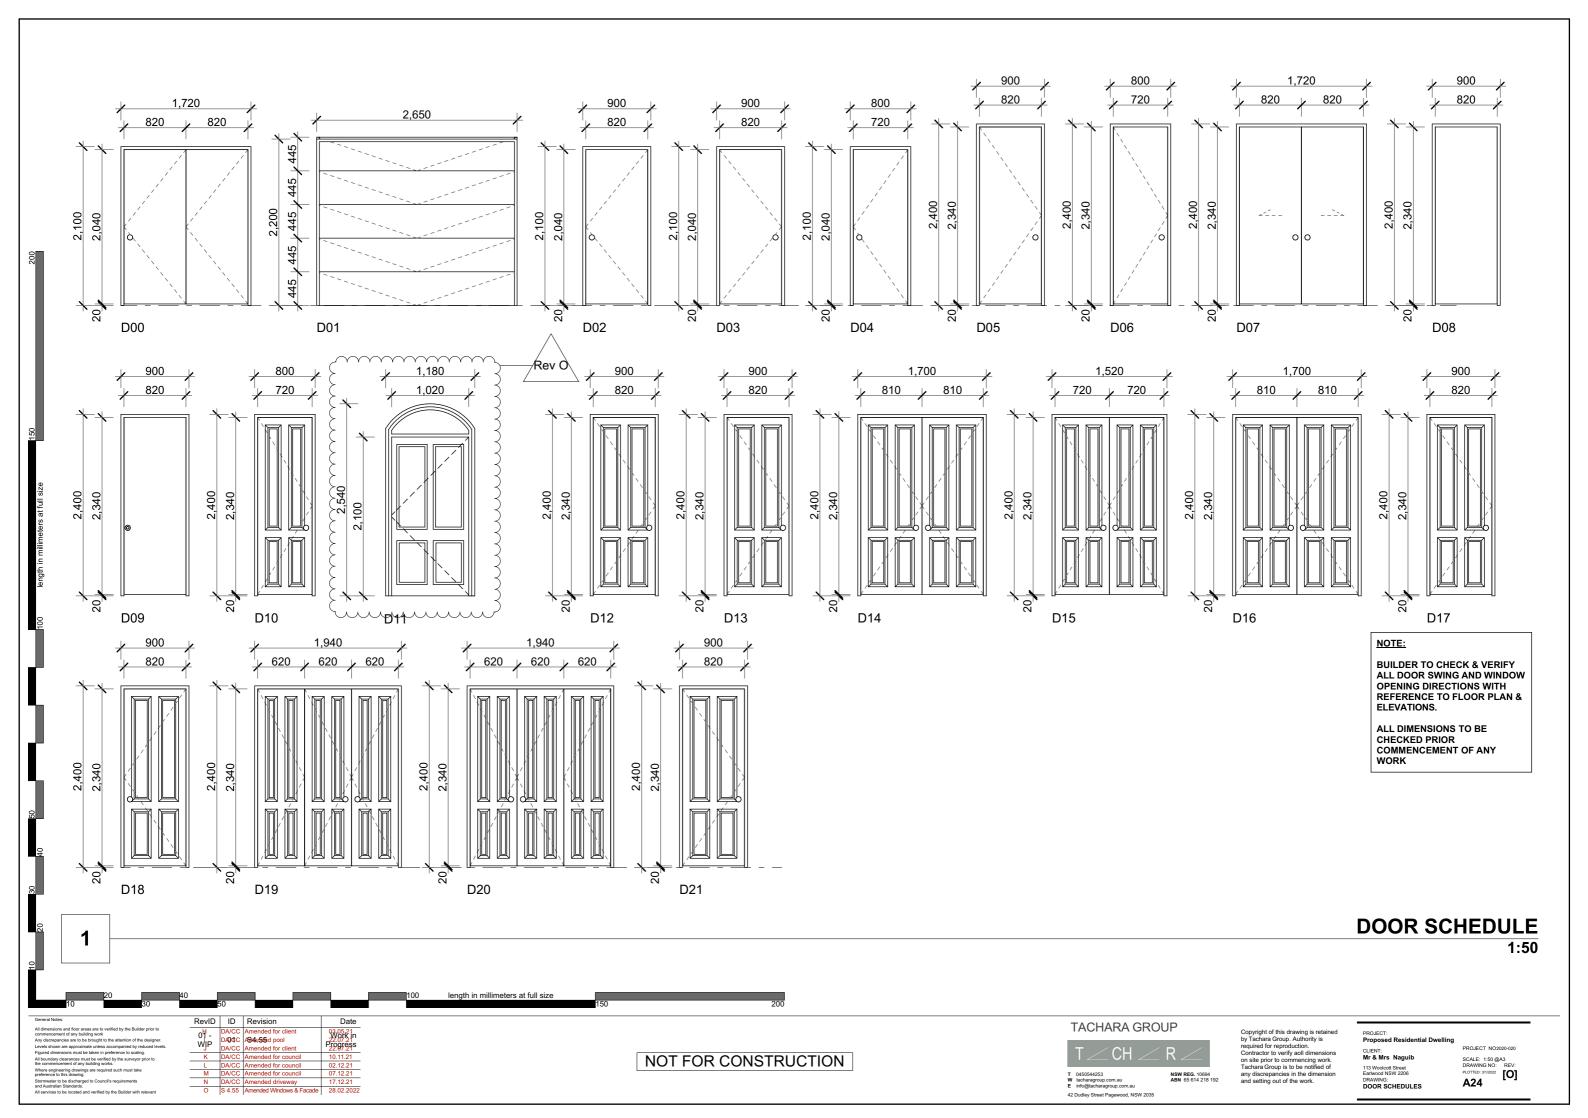

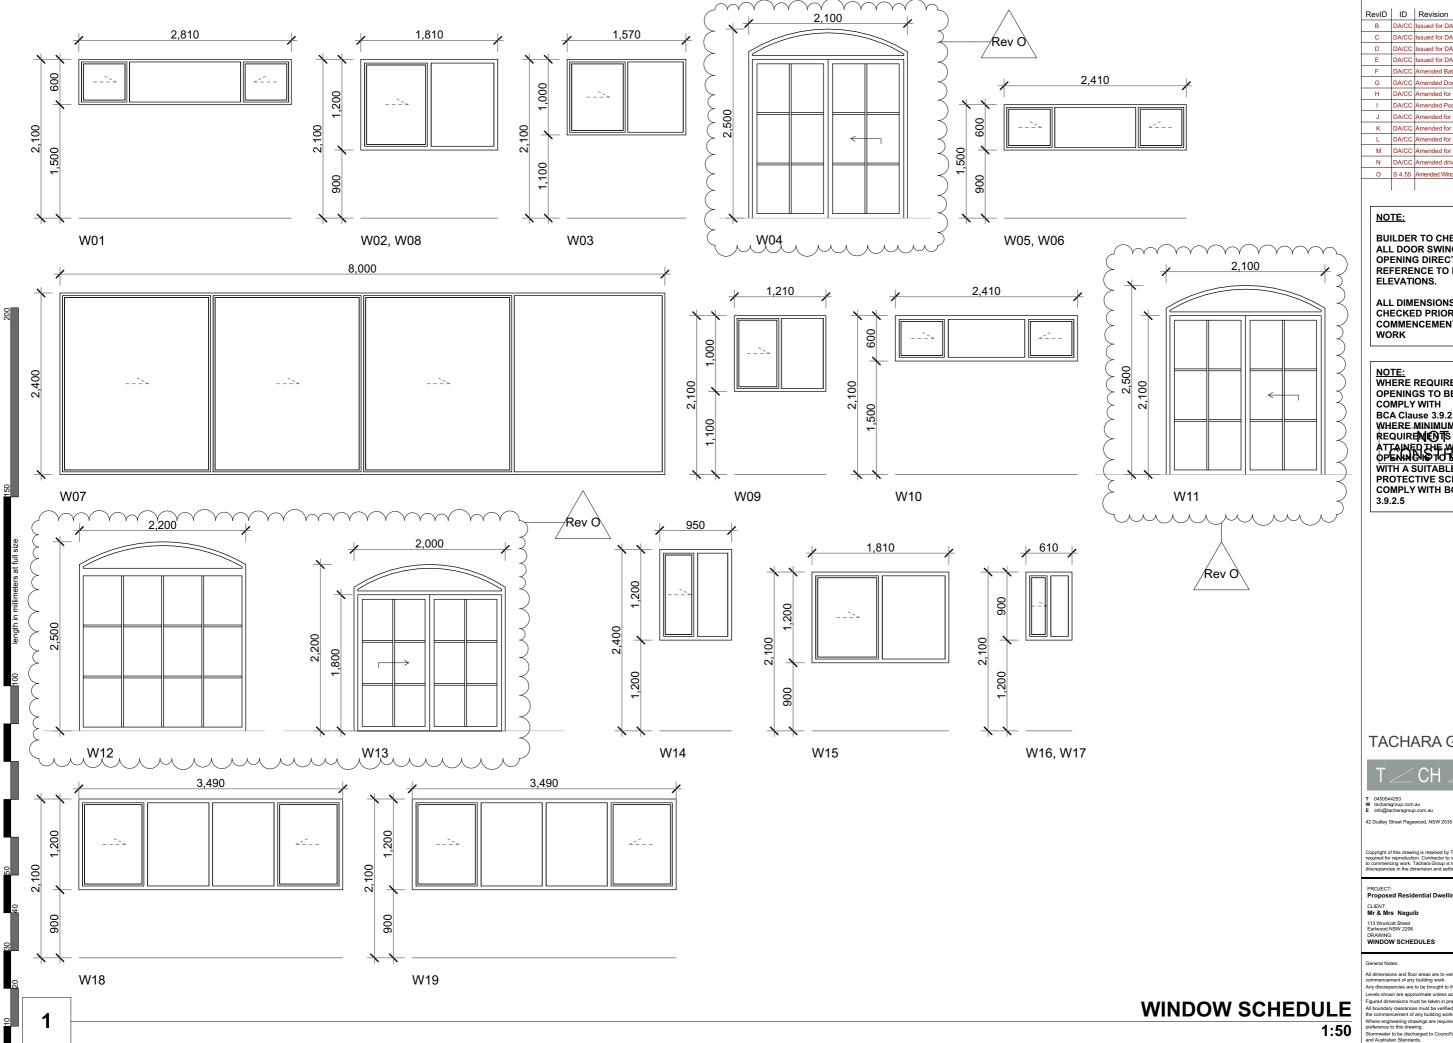

RevID	ID	Revision	Date	
В	DA/CC	Issued for DA/CC	23.09.20	
С	DA/CC	Issued for DA/CC	24.09.20	
D	DA/CC	Issued for DA/CC	21.01.21	
E	DA/CC	Issued for DA/CC	25.01.21	
F	DA/CC	Amended Bathroom	22.02.21	
G	DA/CC	Amended Door Heights	26.02.21	
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M	DA/CC	Amended for council	07.12.21	
N	DA/CC	Amended driveway	17.12.21	
0	S 4.55	Amended Windows & Facade	28.02.22	

BUILDER TO CHECK & VERIFY ALL DOOR SWING AND WINDOW OPENING DIRECTIONS WITH REFERENCE TO FLOOR PLAN & ELEVATIONS.

ALL DIMENSIONS TO BE CHECKED PRIOR COMMENCEMENT OF ANY WORK

NOTE: WHERE REQUIRED WINDOW OPENINGS TO BE FIXED TO **COMPLY WITH** BCA Clause 3.9.2.5
WHERE MINIMUM VENTILATION
REQUIREM TO SEA POT BE
ATTAINED THE WINDOW
OPENING TO SE SECURED WITH A SUITABLE
PROTECTIVE SCREEN TO
COMPLY WITH BCA Clause


TACHARA GROUP





113 Woolcott Street Earlwood NSW 2206 DRAWING: WINDOW SCHEDULES


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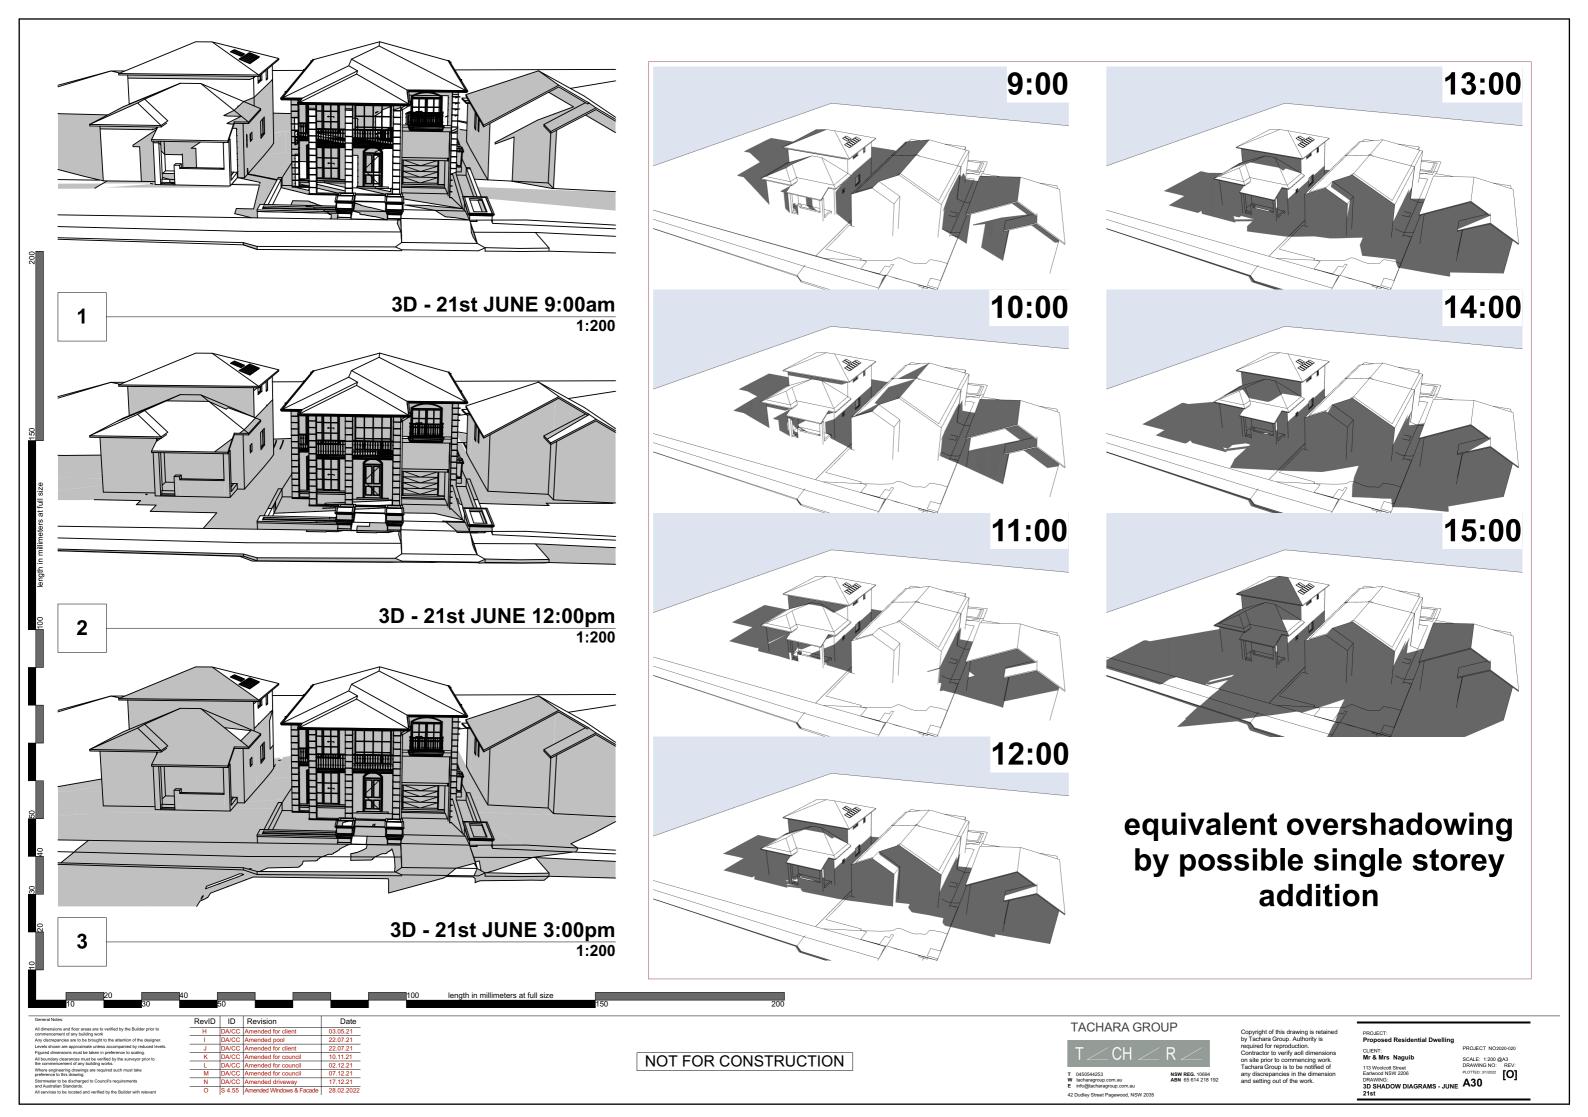
All services to be located and verified by the Builder with relauthorities before any building work commences.




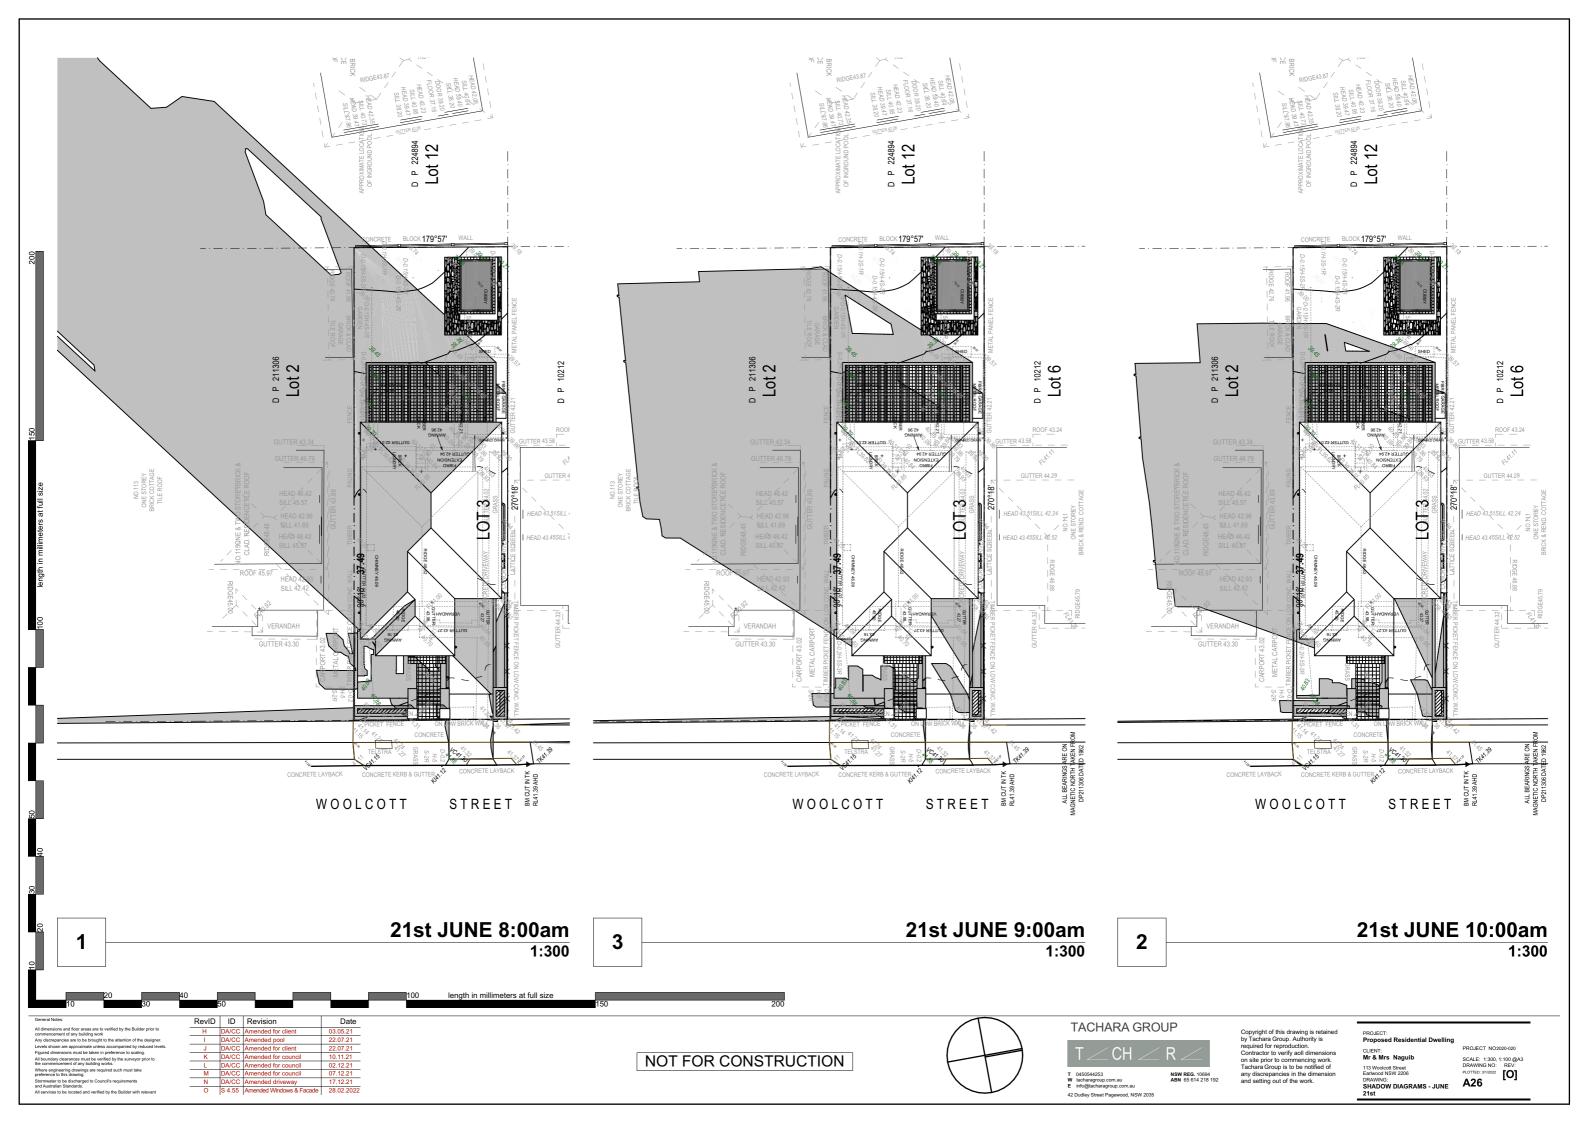

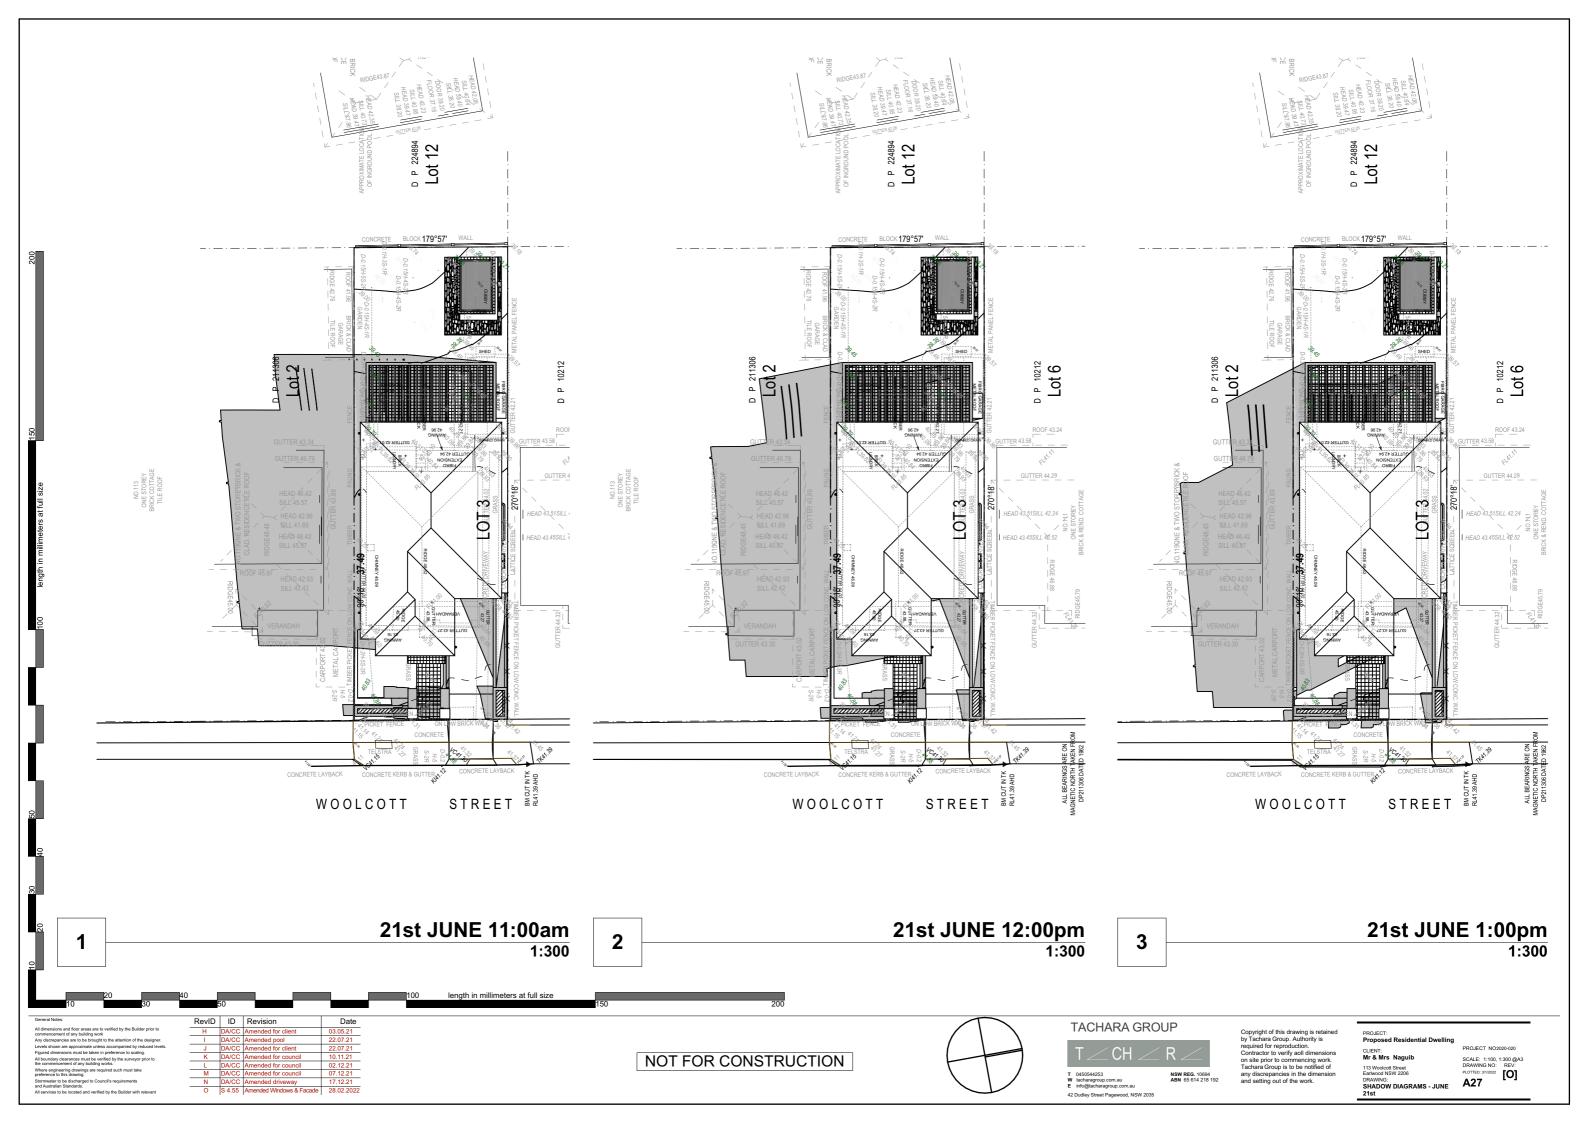

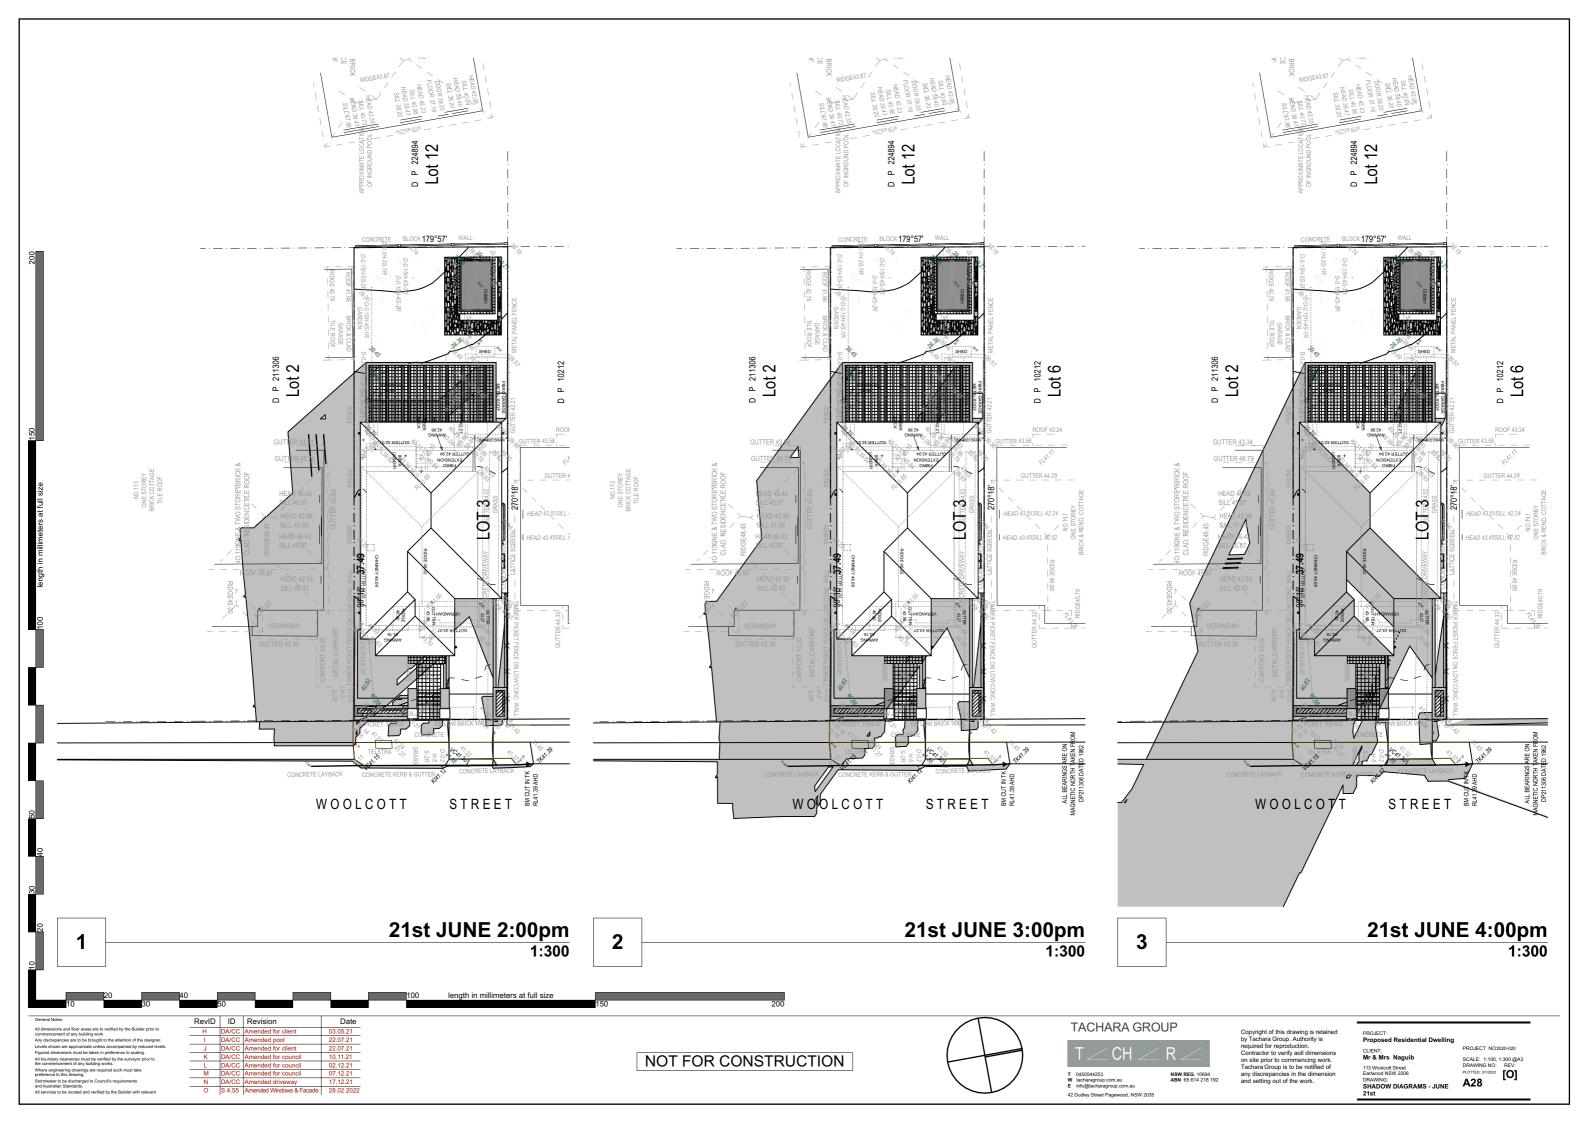

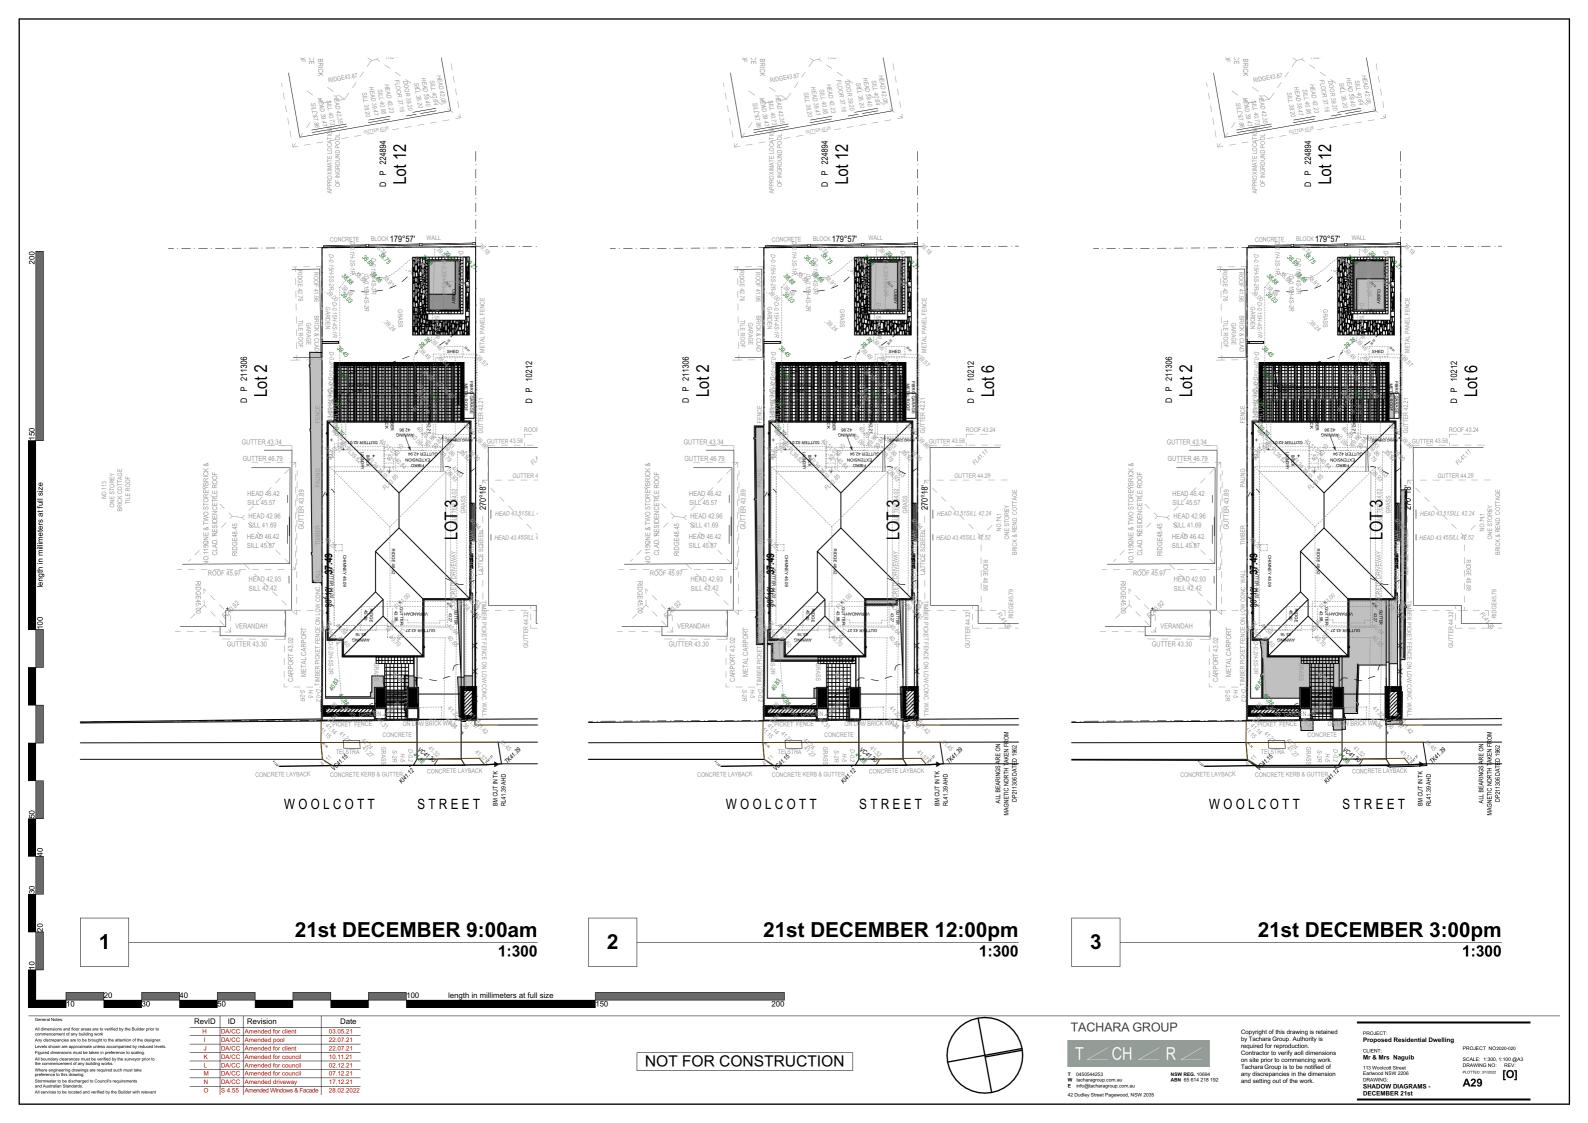

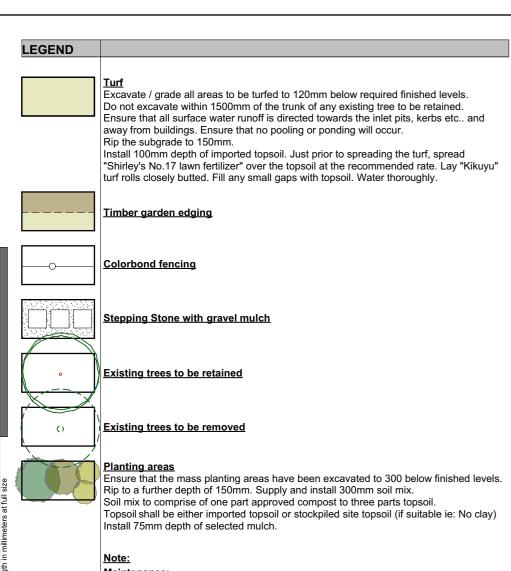


Maintenance:

All landscape works are to be maintained for a period of twelve months from the date of practical completion. This includes all watering, weeding, spraying and re-mulching necessary to achieve vigorous growth. Any defects which arise during this period are to be rectified immediately. Any plants or areas of turf which fail during this period are to be replaced at no additional cost.

Irrigation:

All common areas on the landscape plan are to be covered by a fully automatic irrigation system. The system is to provide a full coverage with no overspray onto paved areas, structures or buildings. The controller is to be equal to a 'Richdell 446 PR' and is to be housed in a control box adjacent to the electricity meter. All sprinkler heads are to be pop-up. All pipework is to be PVC to satisfy AS 1477. All installation is to satisfy the Sydney Water Code and AS 3500. The system is to be installed by a suitable licenced contractor. All equipment and workmanship is to be guaranteed for a minimum period of

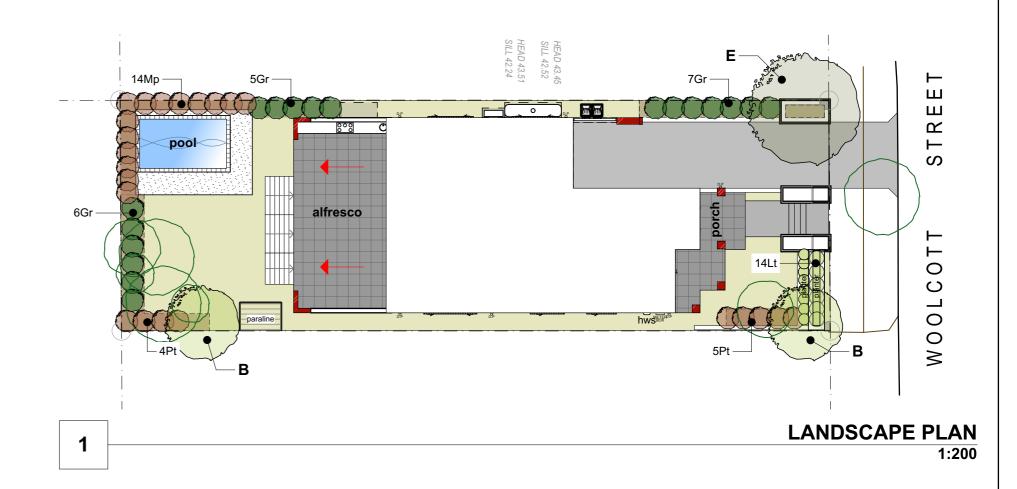

	PLANT SCHEDU	1	E	
Code		Qty	Size	Stake
	, , , , , , , , , , , , , , , , , , ,			
Trees				
В	Brachychiton populeus (Flame Tree - 8)	2	75 litre	yes
E	Elaecarpus reticulatus (Blue berry ash - 8m)	1	75 litre	yes
Shrubs				
De	Doryanthus excelsa (Gymea lilly - 1m)	3	5 litre	_
Mp	Doryanthus excelsa (Gymea lilly - 1m)	14	5 litre	_
Gr	Grevillea robyn gordon (Grevillea - 2m)	18	5 litre	
Pt	Phormium tenax (NZ flax - 1m)	16	5 litre	_
Groundcovers				
Lt	Lomandra longifolia 'Tanika' (fine leaf dwarf lomandra - 0.6m)	14	150mm pot	

RevID ID Revision



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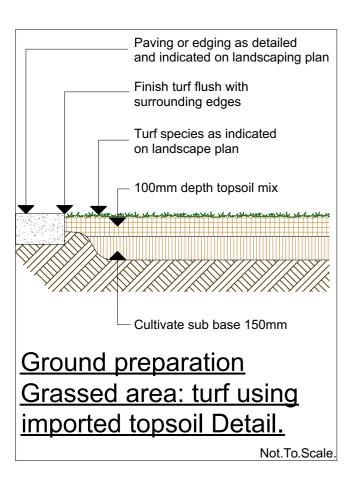
42 Dudley Street Pagewood, NSW 2035





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Contractor to verify all dimensions on site prior to commencing work.
Tachara Group is to be notified of any discrepancies in the dimension.


CLIENT: Mr & Mrs Naguib


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DRAWING NO: REV:
PLOTTED: 3/1/2022 [O]



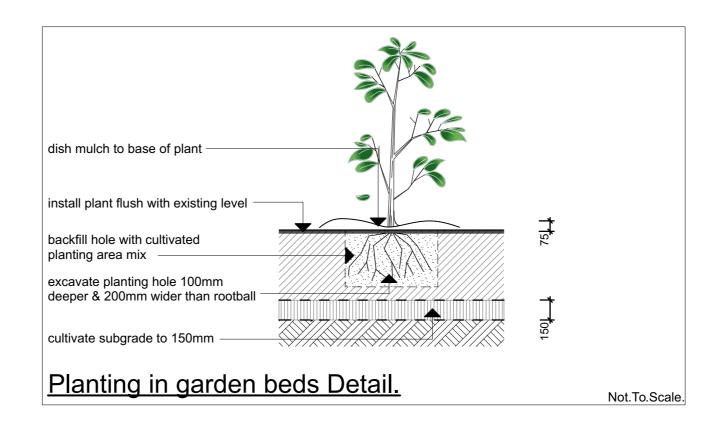

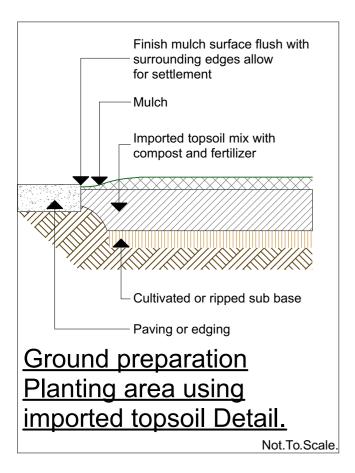

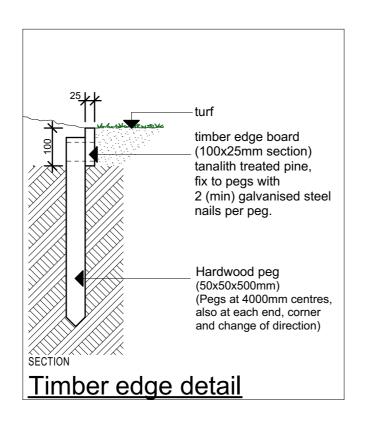

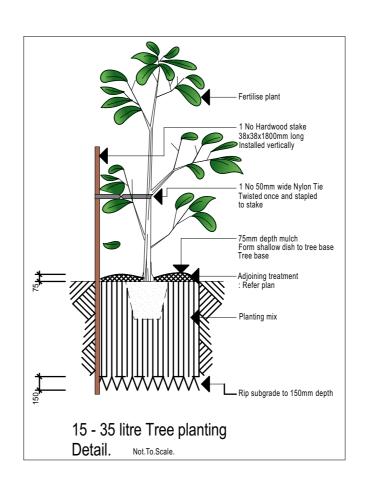

RevID ID Revision 22.02.21 22.07.21 22.07.21 07.12.21

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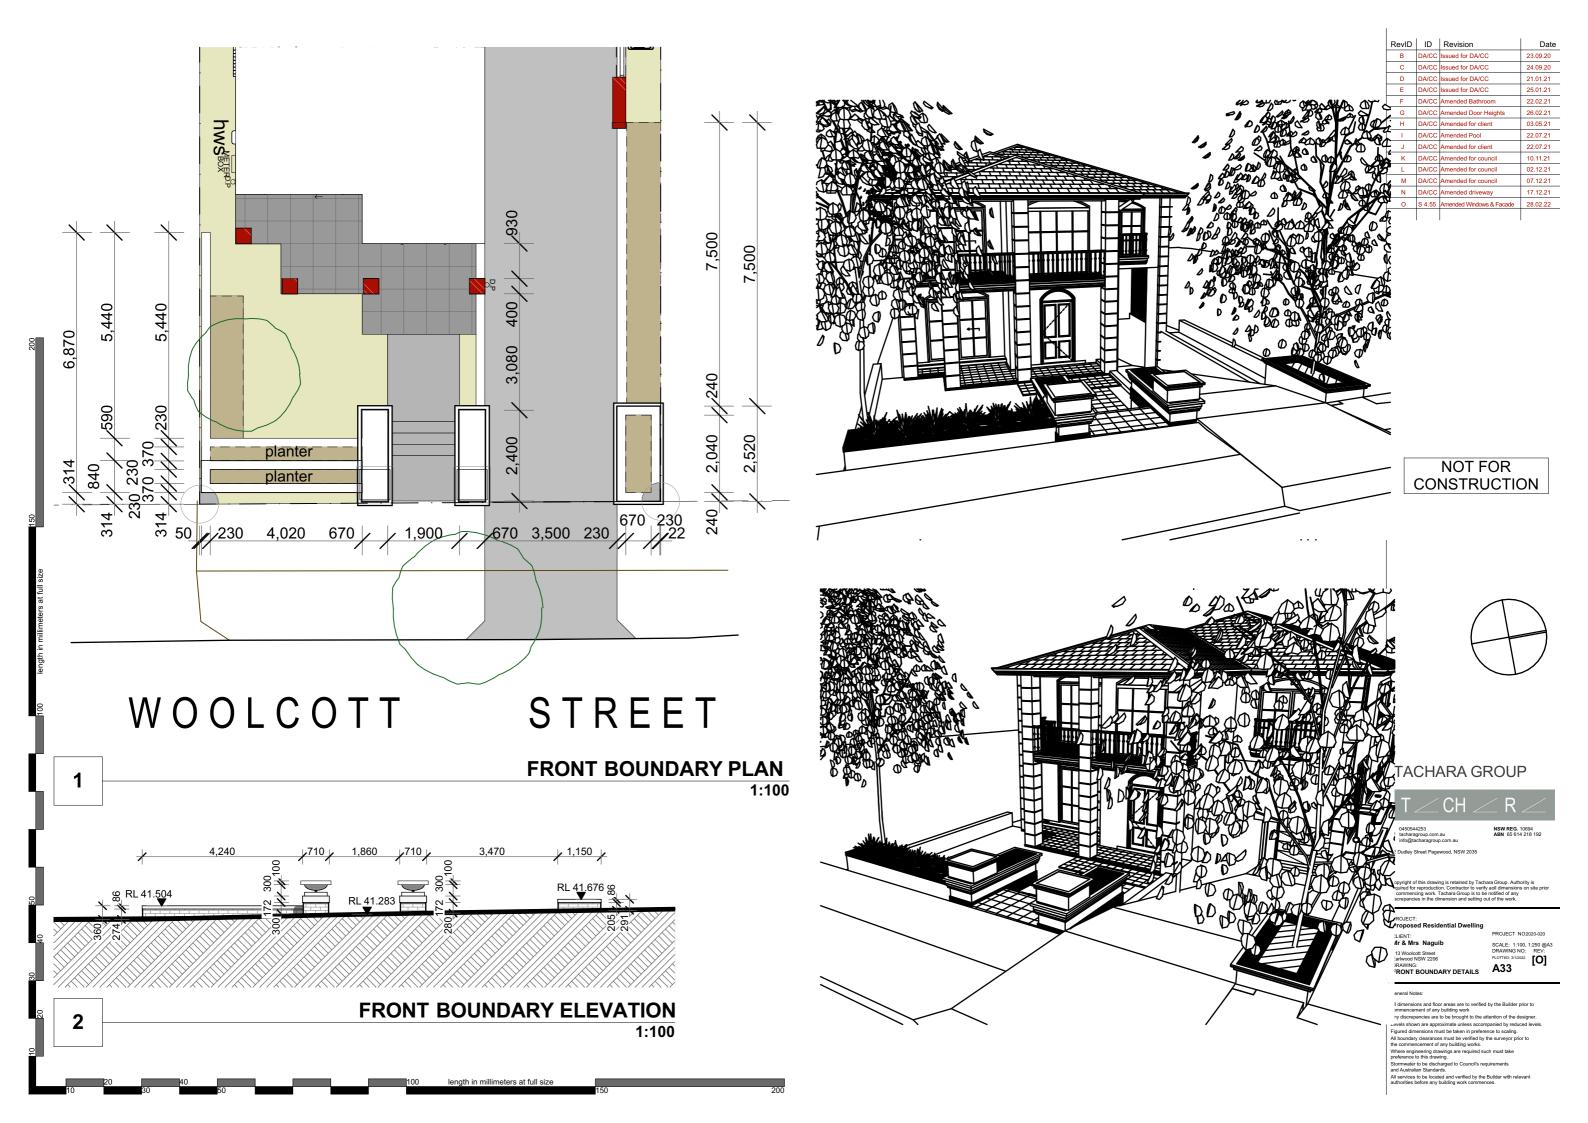


12 Dudley Street Pagewood, NSW 2035

CLIENT: Mr & Mrs Naguib

LANDSCAPE DETAILS

A32





Materiality 1:1.67



RevID ID Revision DA/CC Amended for client
DA/CC Amended for client
DA/CC Amended for client
K DA/CC Amended for council
M DA/CC Amended for council
N DA/CC Amended for council

1

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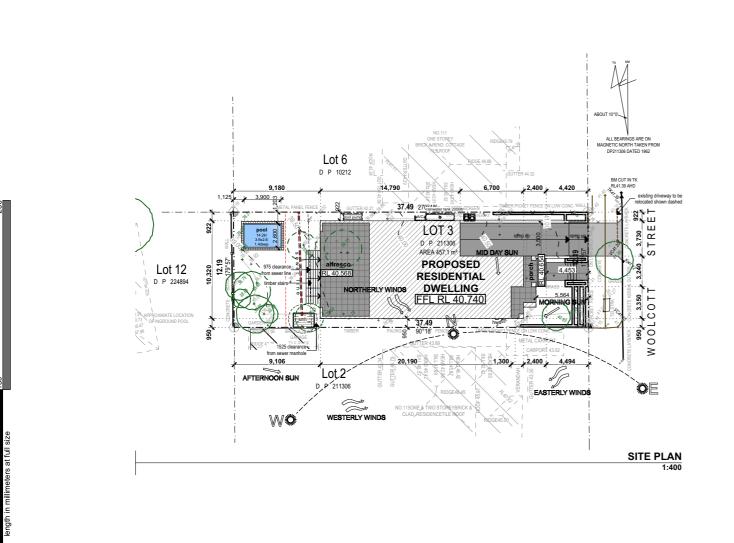
T 0450544253 W tacharagroup.com.au E info@tacharagroup.com.au 42 Dudley Street Pagewood, NSW 2035


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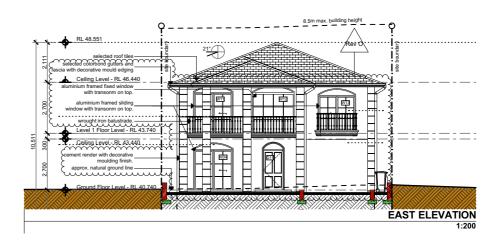
CLIENT: Mr & Mrs Naguib


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PLOTTED: 3/1/2022


A34 113 Woolcott Street Earlwood NSW 2206 DRAWING: SCHEDULE OF EXTERNAL FINISHES





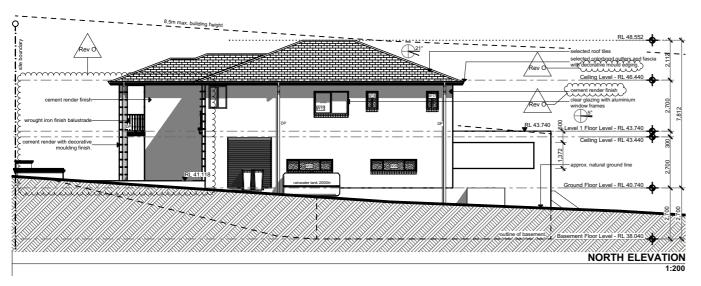

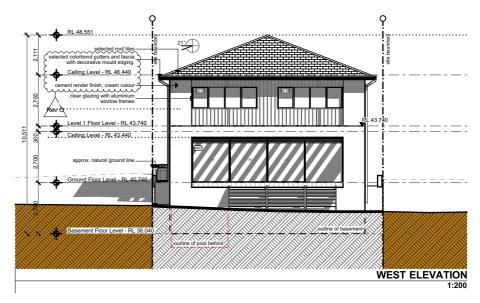

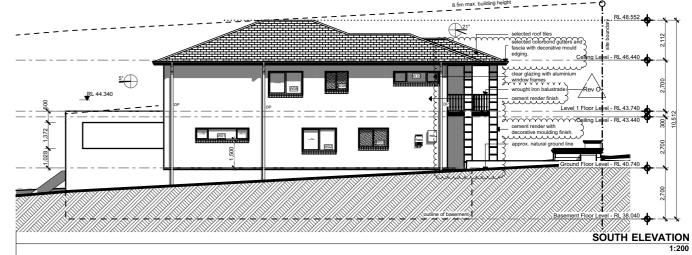

03.05.21 Wyork in Progress 10.11.21 DA/CC Amended for client
DA/CC Amended for client
DA/CC Amended for client
DA/CC Amended for council
DA/CC Amended for council
DA/CC Amended for council
DA/CC Amended for council

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CLIENT: Mr & Mrs Naguib

SCALE: 1:125, 1:400, 1:200 @A3 DRAWING NO: REV: PLOTTED: 3/1/2022 [O] 113 Woolcott Street Earlwood NSW 2206 DRAWING: NOTIFICATION PLAN A35



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Mr & Mrs Naguib

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Earlwood NSW 2206
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